AVIGNON OFFICE PARK

RIDGELAND, MISSISSIPPI

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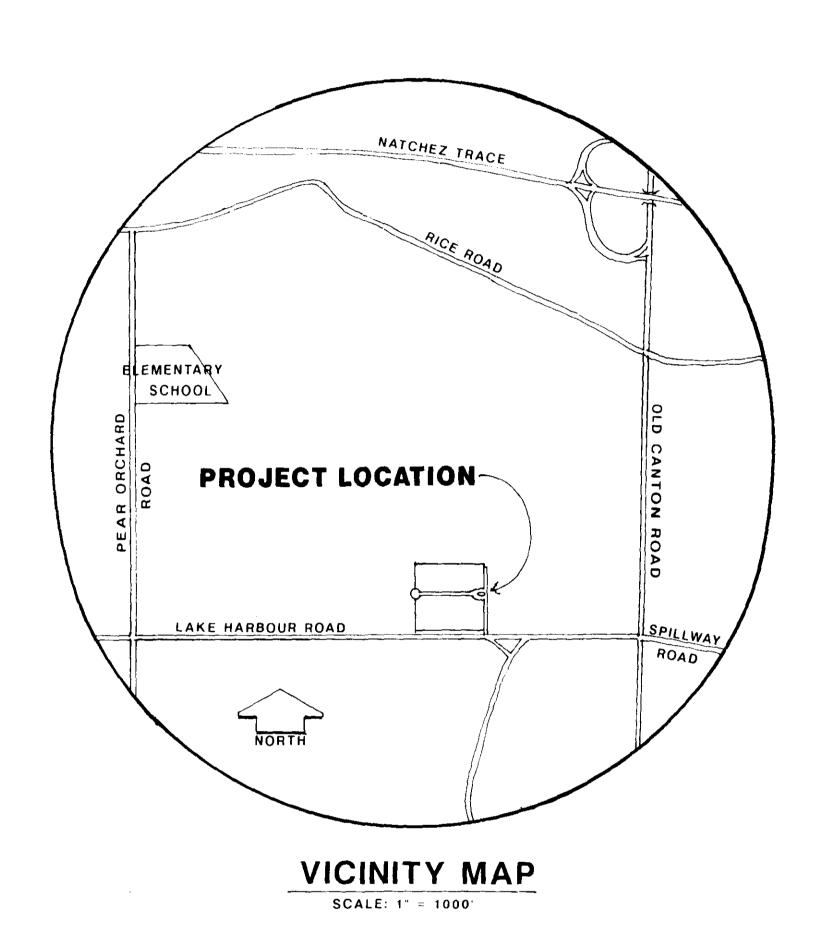
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- 2. ELEVATION
- 3. GUARD HOUSE PLAN
- 4. DETAIL SHEET
- 5. DETAIL SHEET
- 6. GRADING PLAN
- 7. PLANTING PLAN
- 8. PLANTING DETAILS
- 9. LIGHTING PLANS
- 10. LIGHTING DETAILS


DEVELOPED BY:

CRESS DEVELOPMENT, INC.


PREPARED BY:






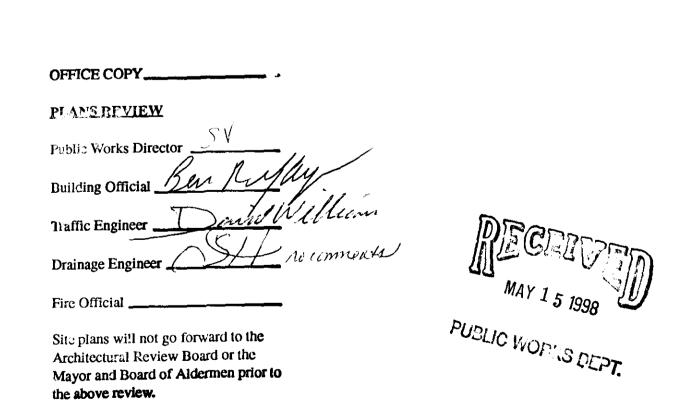

PWP-00104

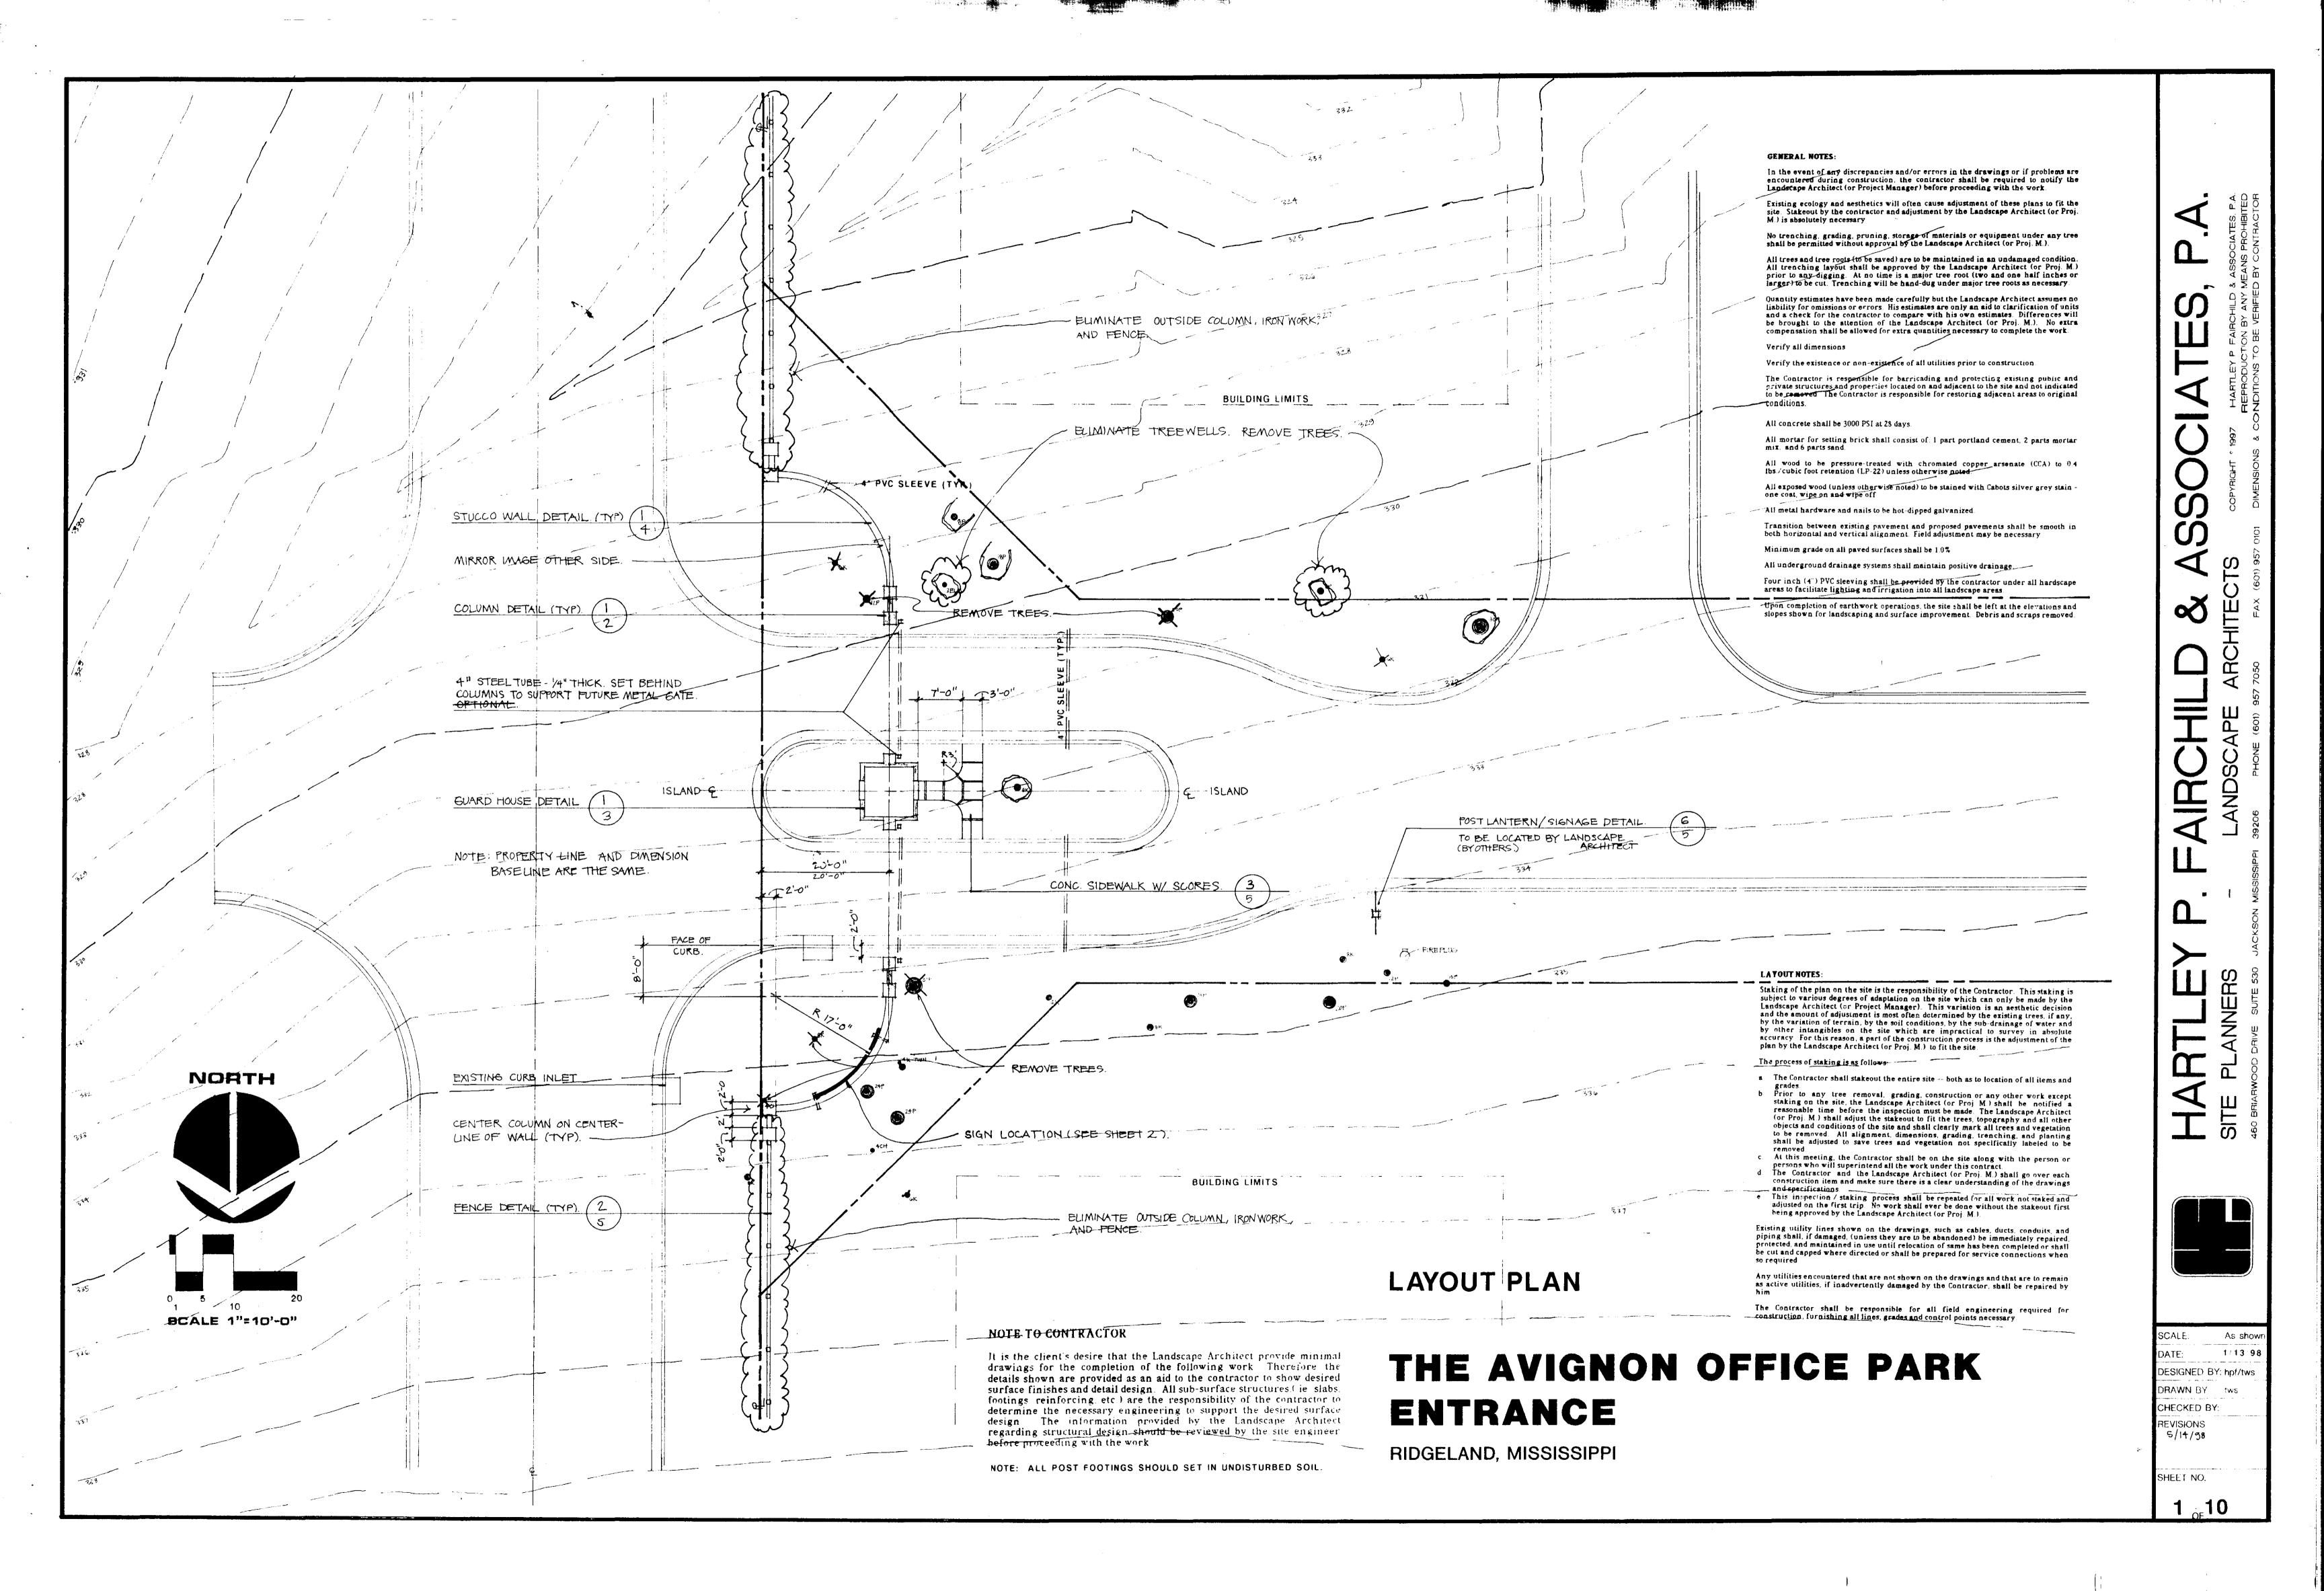

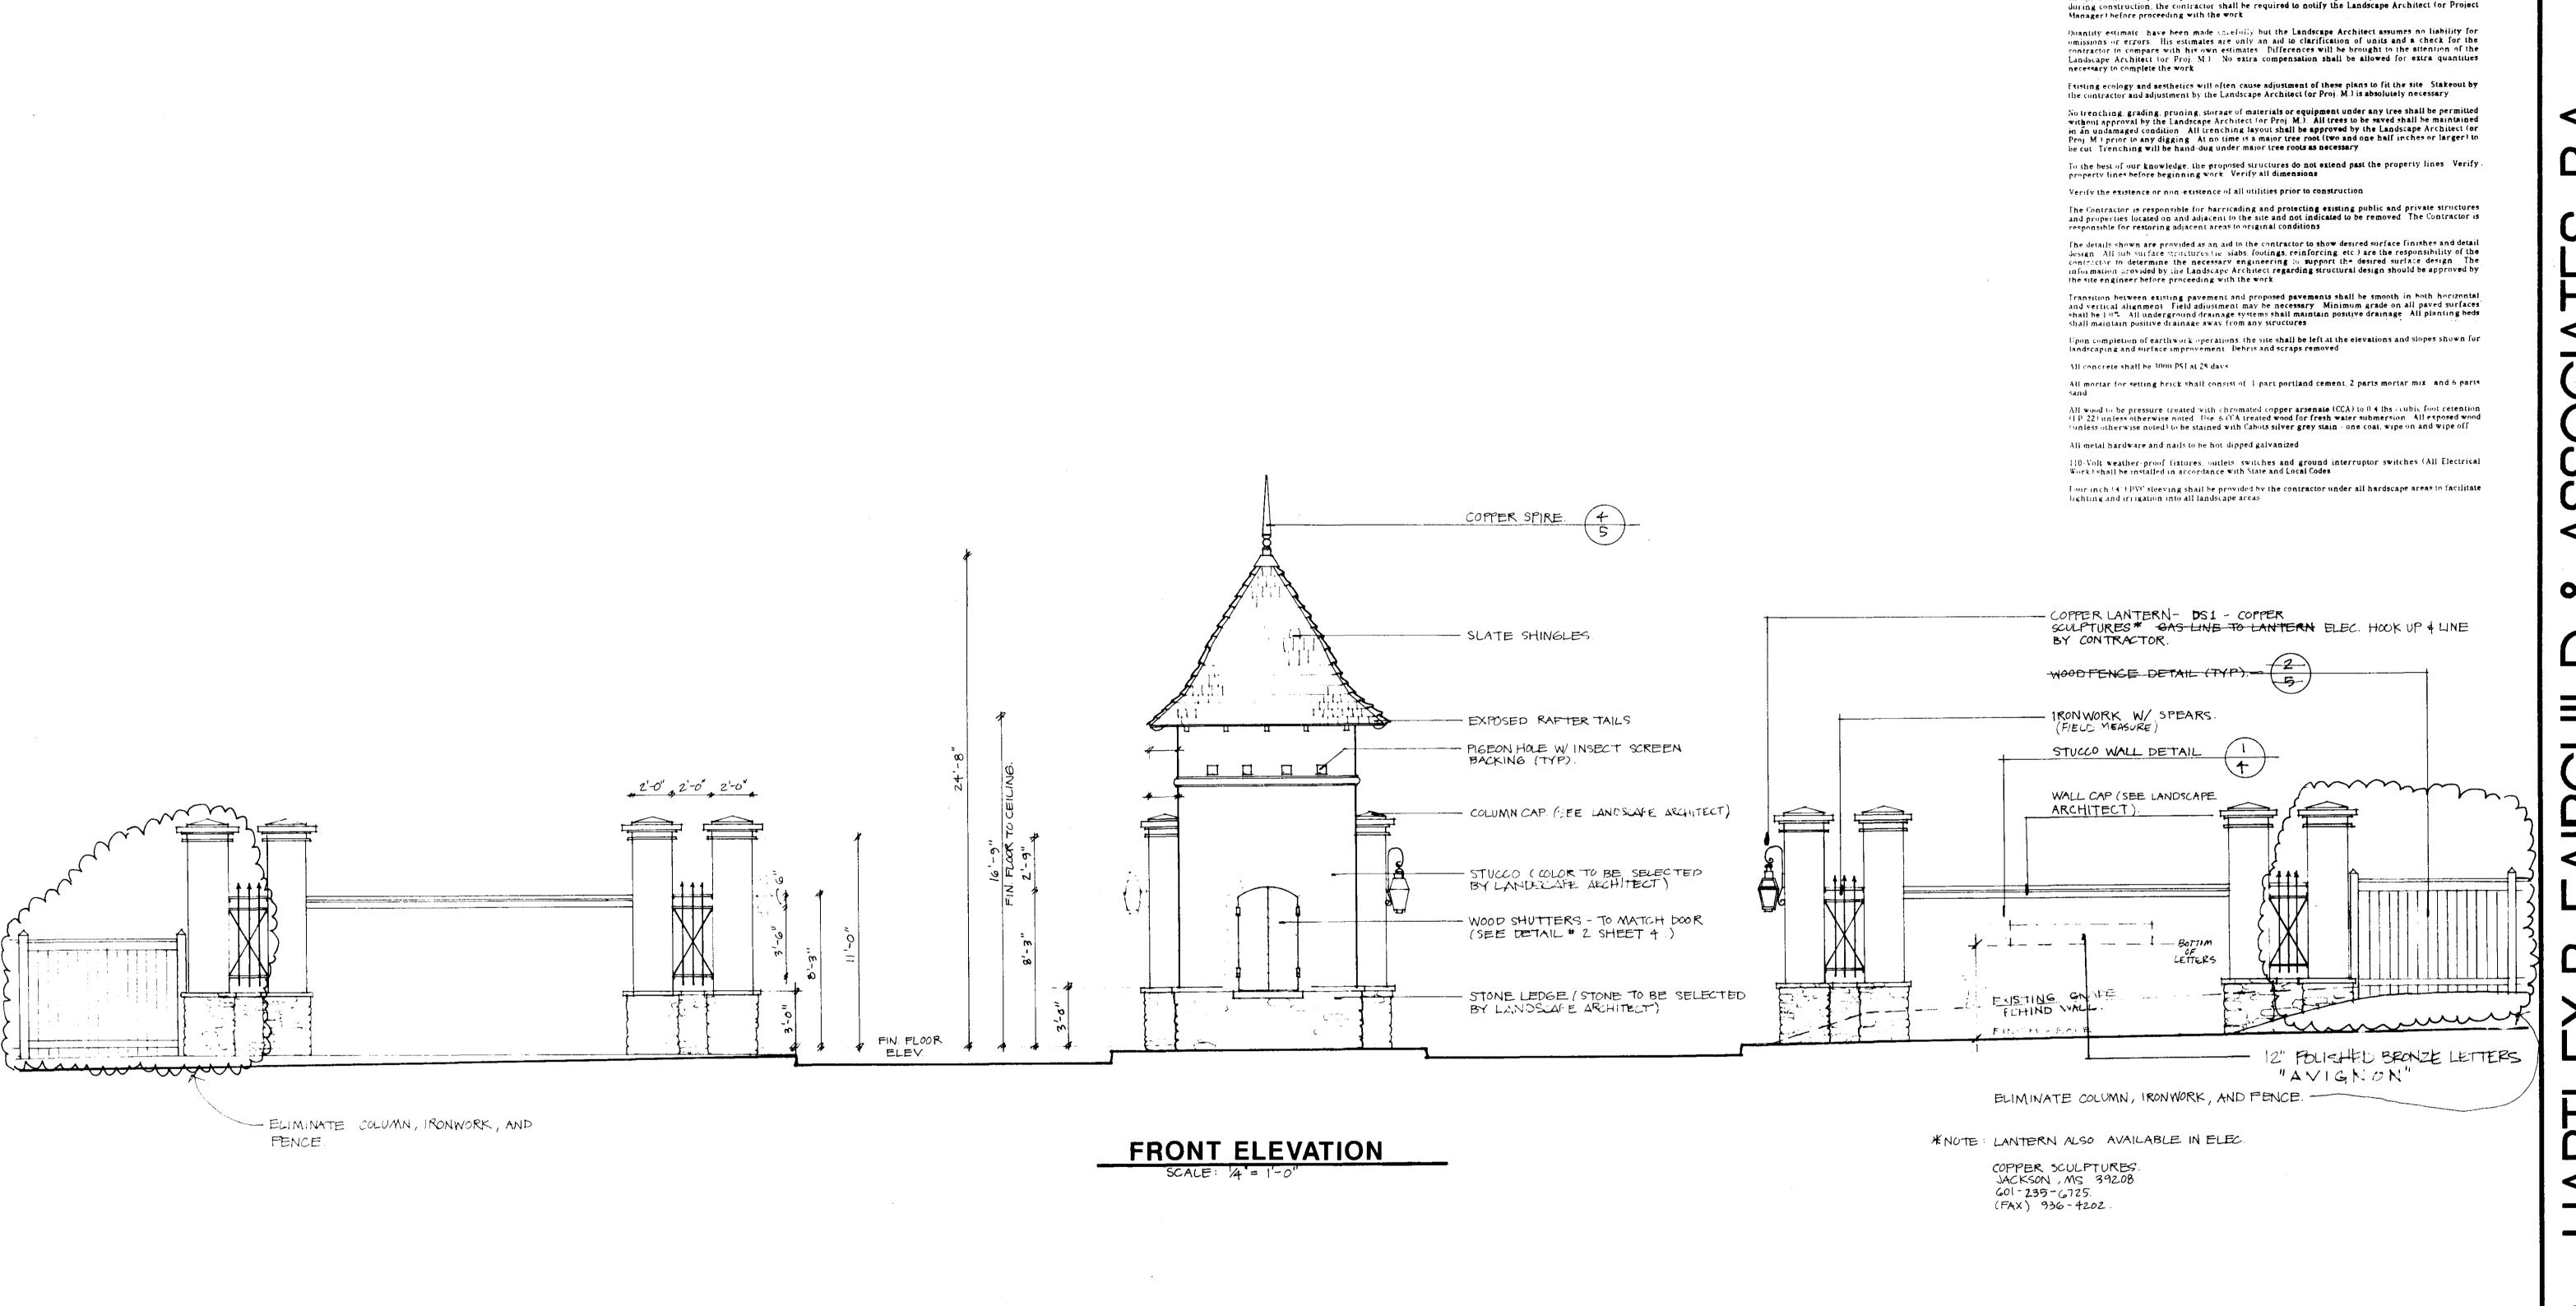

NOTE TO CONTRACTOR

It is the client's desire that the Landscape Architect provide minimal drawings for the completion of the following work. Therefore the details shown are provided as an aid to the contractor to show desired surface finishes and detail design. All sub-surface structures, ie slabs footings reinforcing etc. are the responsibility of the contractor to determine the necessary engineering to support the desired surface design. The information provided by the Landscape Architect regarding structural design should be reviewed by the site engineer before proceeding with the work.

THE AVIGNON OFFICE PARK ENTRANCE

GENERAL NOTES:

In the event of any discrepancies and/or errors in the drawings or if problems are encountered

RIDGELAND, MISSISSIPPI

SEE SHEET FOR LAYOUT NOTES

SCALE: As show

DATE: 12/22/97

DESIGNED BY: hpf/tws

DRAWN BY: tws

CHECKED BY:


REVISIONS

2/25/98


5/14/98

SHEET NO.


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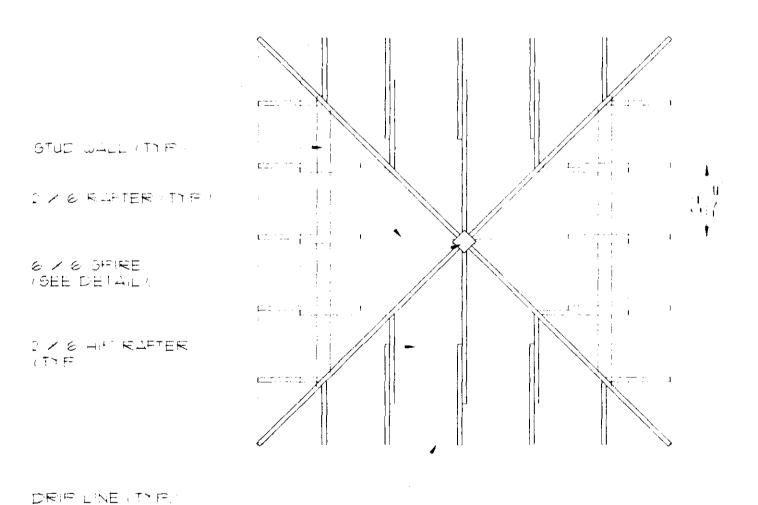


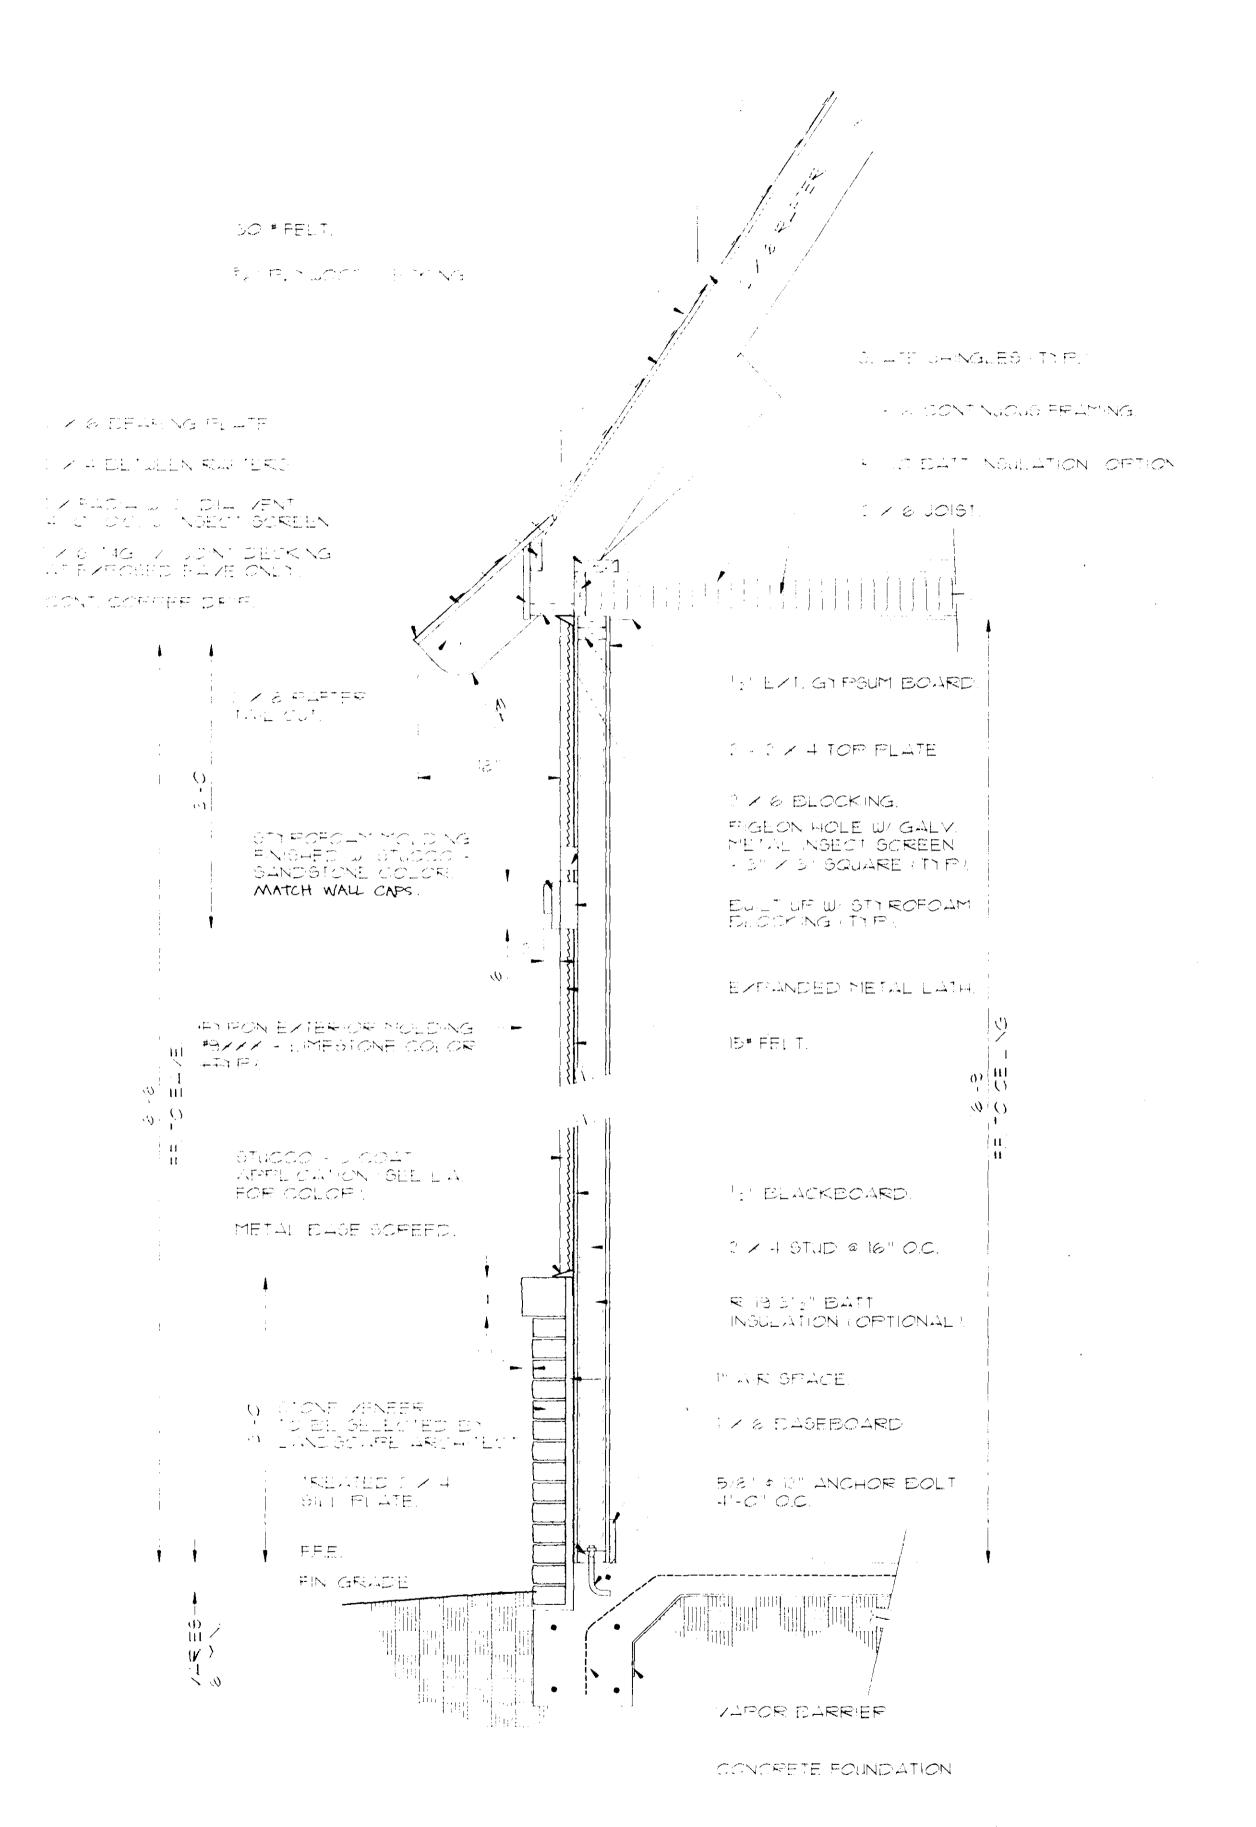TYPICAL WALL SECTION

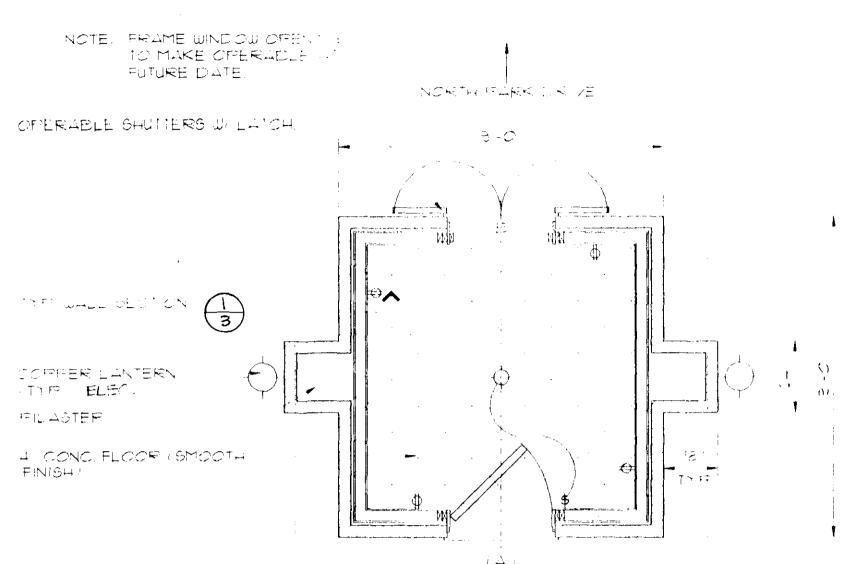

FLOORPLAN



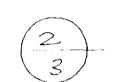

ROOF PLAN



GENERAL NOTES

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All trees and tree roots (to be saved) are to be maintained in an undamaged condition. All trenching layout shall be approved by the Landscape Architect for Proj. M) prior to any digging. At no time is a major tree root (two and one half inches or larger) to be cut. Trenching will be hand dug under major tree roots as necessary.

Quantity estimates have been made carefully but the Landscape Architect assumes no hability for omissions or errors. This estimates are only an aid to clarification of units and a check for the contractor to compare with his own estimates. Differences will be brought to the attention of the Landscape Architect (or Proj. M). No extra compensation shall be allowed for extra quantities necessary to complete the work.

Verify all dimensions

Verify the existence or non-existence of all utilities prior to construction

The Contractor is responsible for barricading and protecting existing public and private structures and properties located on and adjacent to the site and not indicated to be removed. The Contractor is responsible for restoring adjacent areas to original conditions.

All concrete shall be 3000 PSI at 28 days

All mortal for selting brick shall consist of -1 part portland cement, 2 parts mortal mix, and 6 parts sand

All wood to be pressure treated with chromated copper arsenate (CCA) to 0.4. Ibs://cubic.foot_retention (TP-22) unless otherwise noted.

All exposed wood (unless otherwise noted) to be stained with Cabots silver grey stain one coat, wipe on and wipe off

All metal bardware and nails to be hot dipped galvanized.

Transition between existing pavement and proposed pavements shall be smooth in

Transition between existing pavement and proposed pavements shall be smooth both horizontal and vertical alignment. Field adjustment may be necessary

Minimum grade on all paved surfaces shall be 10%

All underground drainage systems shall maintain positive drainage

Four meh (4°) PVC sleeving shall be provided by the contractor under all hardscape areas to facilitate lighting and irrigation into all landscape areas

Upon completion of earthwork operations, the site shall be left at the elevations and stopes shown for landscaping and surface improvement. Debris and scraps removed

LEGEND

A - OPERABLE LAMINATED CUSTOM WOOD DOOR. 3 x 8

B - FIXED IN PLACE LAMINATED CUSTOM WOOD SHUTTER. 3 x 5

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DETAILS

THE AVIGNON OFFICE PARK ENTRANCE

RIDGELAND, MISSISSIPPI


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SCALE: As show
DATE: 09/16/97
DESIGNED BY:hpf/tws
DRAWN BY: tws
CHECKED BY:
REVISIONS


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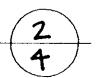


NOTE: ALL POST FOOTINGS SHOULD BE SET IN UNDISTURBED SOIL.



STUCCO WALL DETAIL

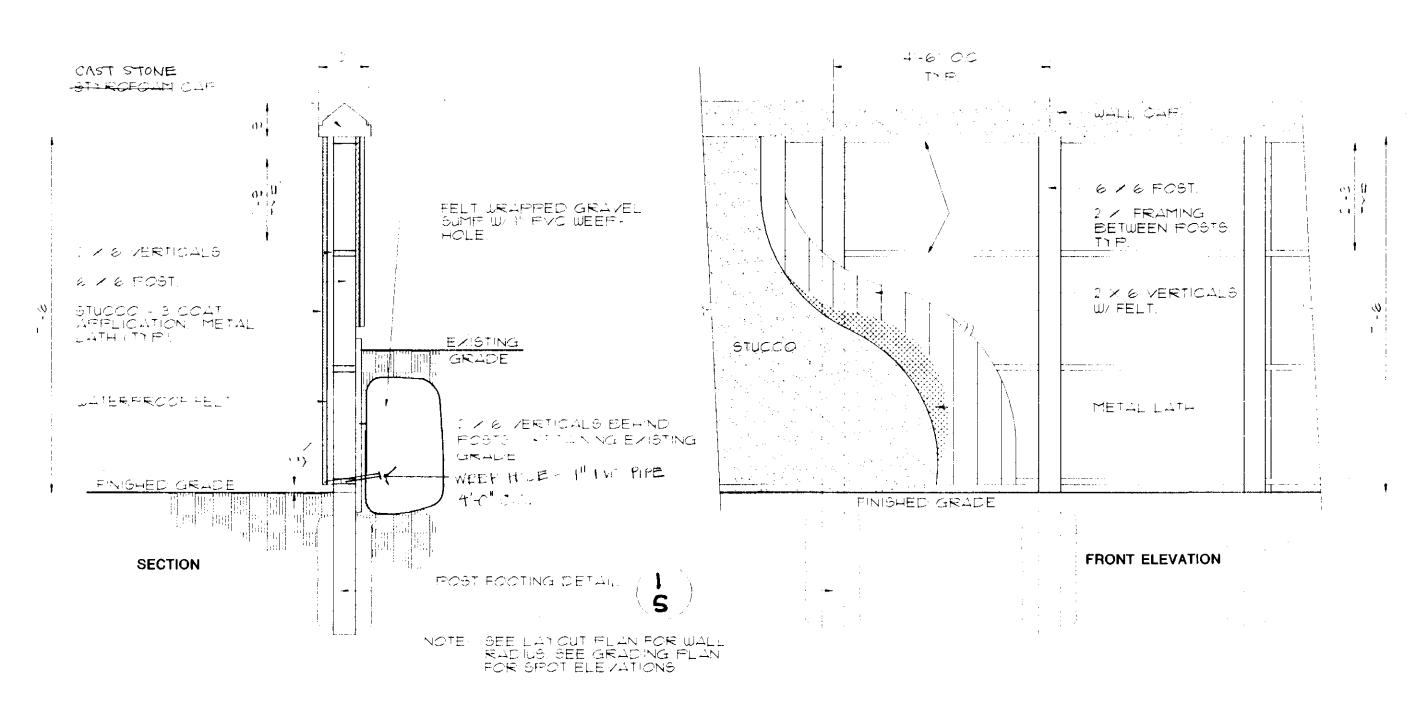CUSTOM DOOR DETAIL

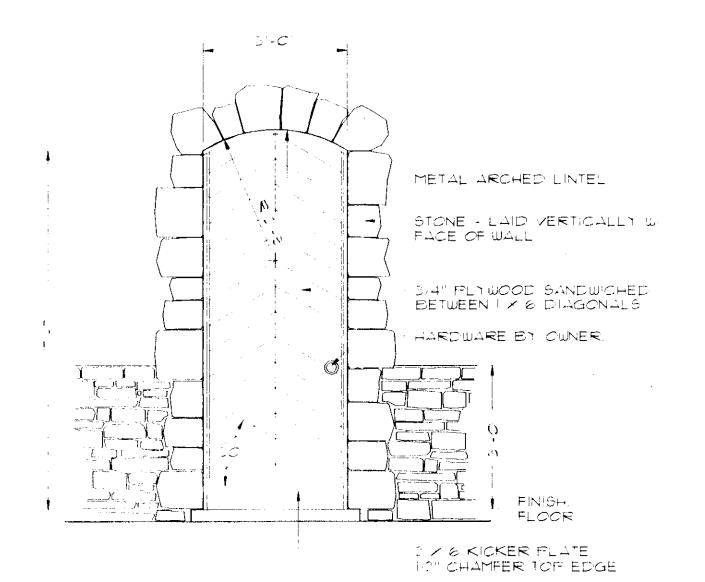

DETAILS

THE AVIGNON OFFICE PARK ENTRANCE

RIDGELAND, MISSISSIPPI

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PLAN SECTION

DE TREATED FLYWOOD

1 & VERTICALS

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1 / 6 FRAME - SCRIBED FROM 1 / 8

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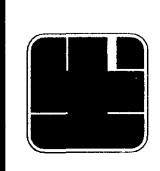
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EY P. FAIRCHILD & ASSOCIATES, F

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SITE PLANNE




SCALE: As shown
DATE: 01/15/98
DESIGNED BY:hpf/tws
DRAWN BY: tws
CHECKED BY:
REVISIONS

SHEET NO.

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2/25/98 5/14/98

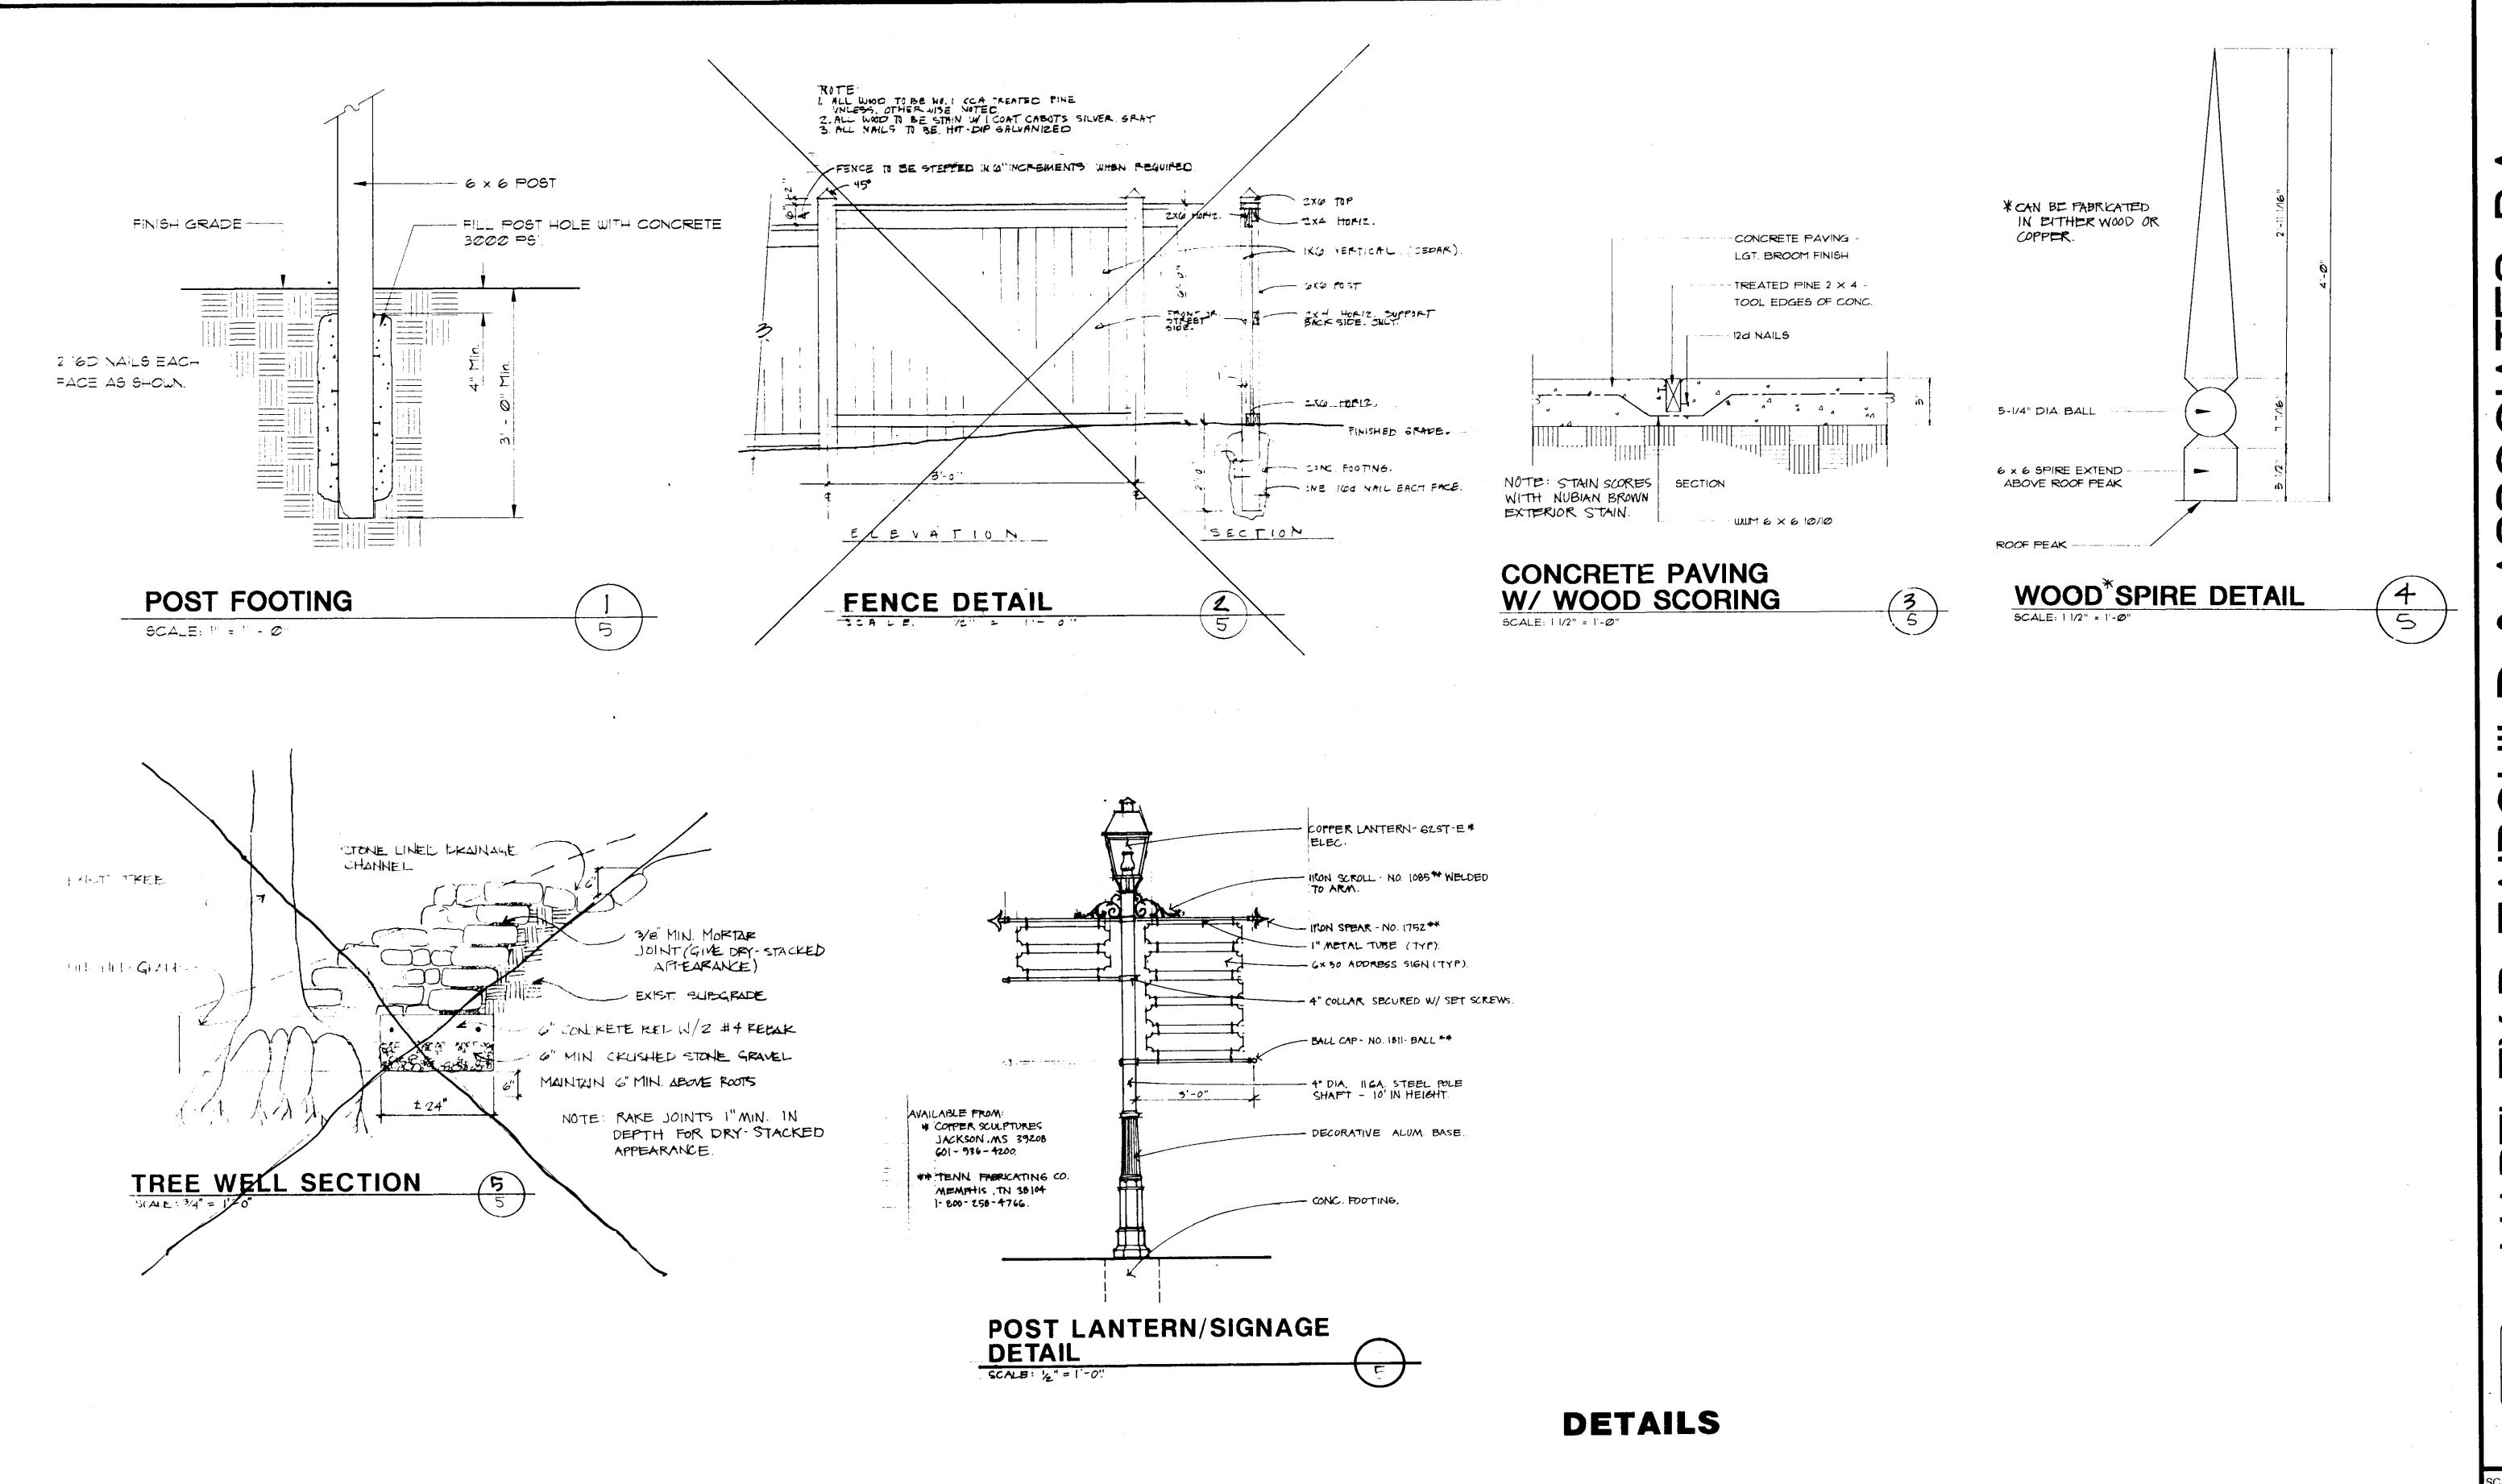

DESIGNED BY: hpf/tw DRAWN BY: CHECKED BY: REVISIONS 2/25/98 5/14/98


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THE AVIGNON OFFICE PARK


ENTRANCE

RIDGELAND, MISSISSIPPI

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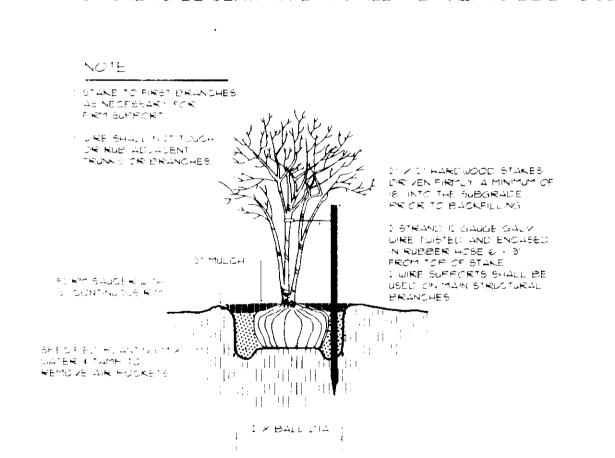
DESIGNED BY: hpf/tws

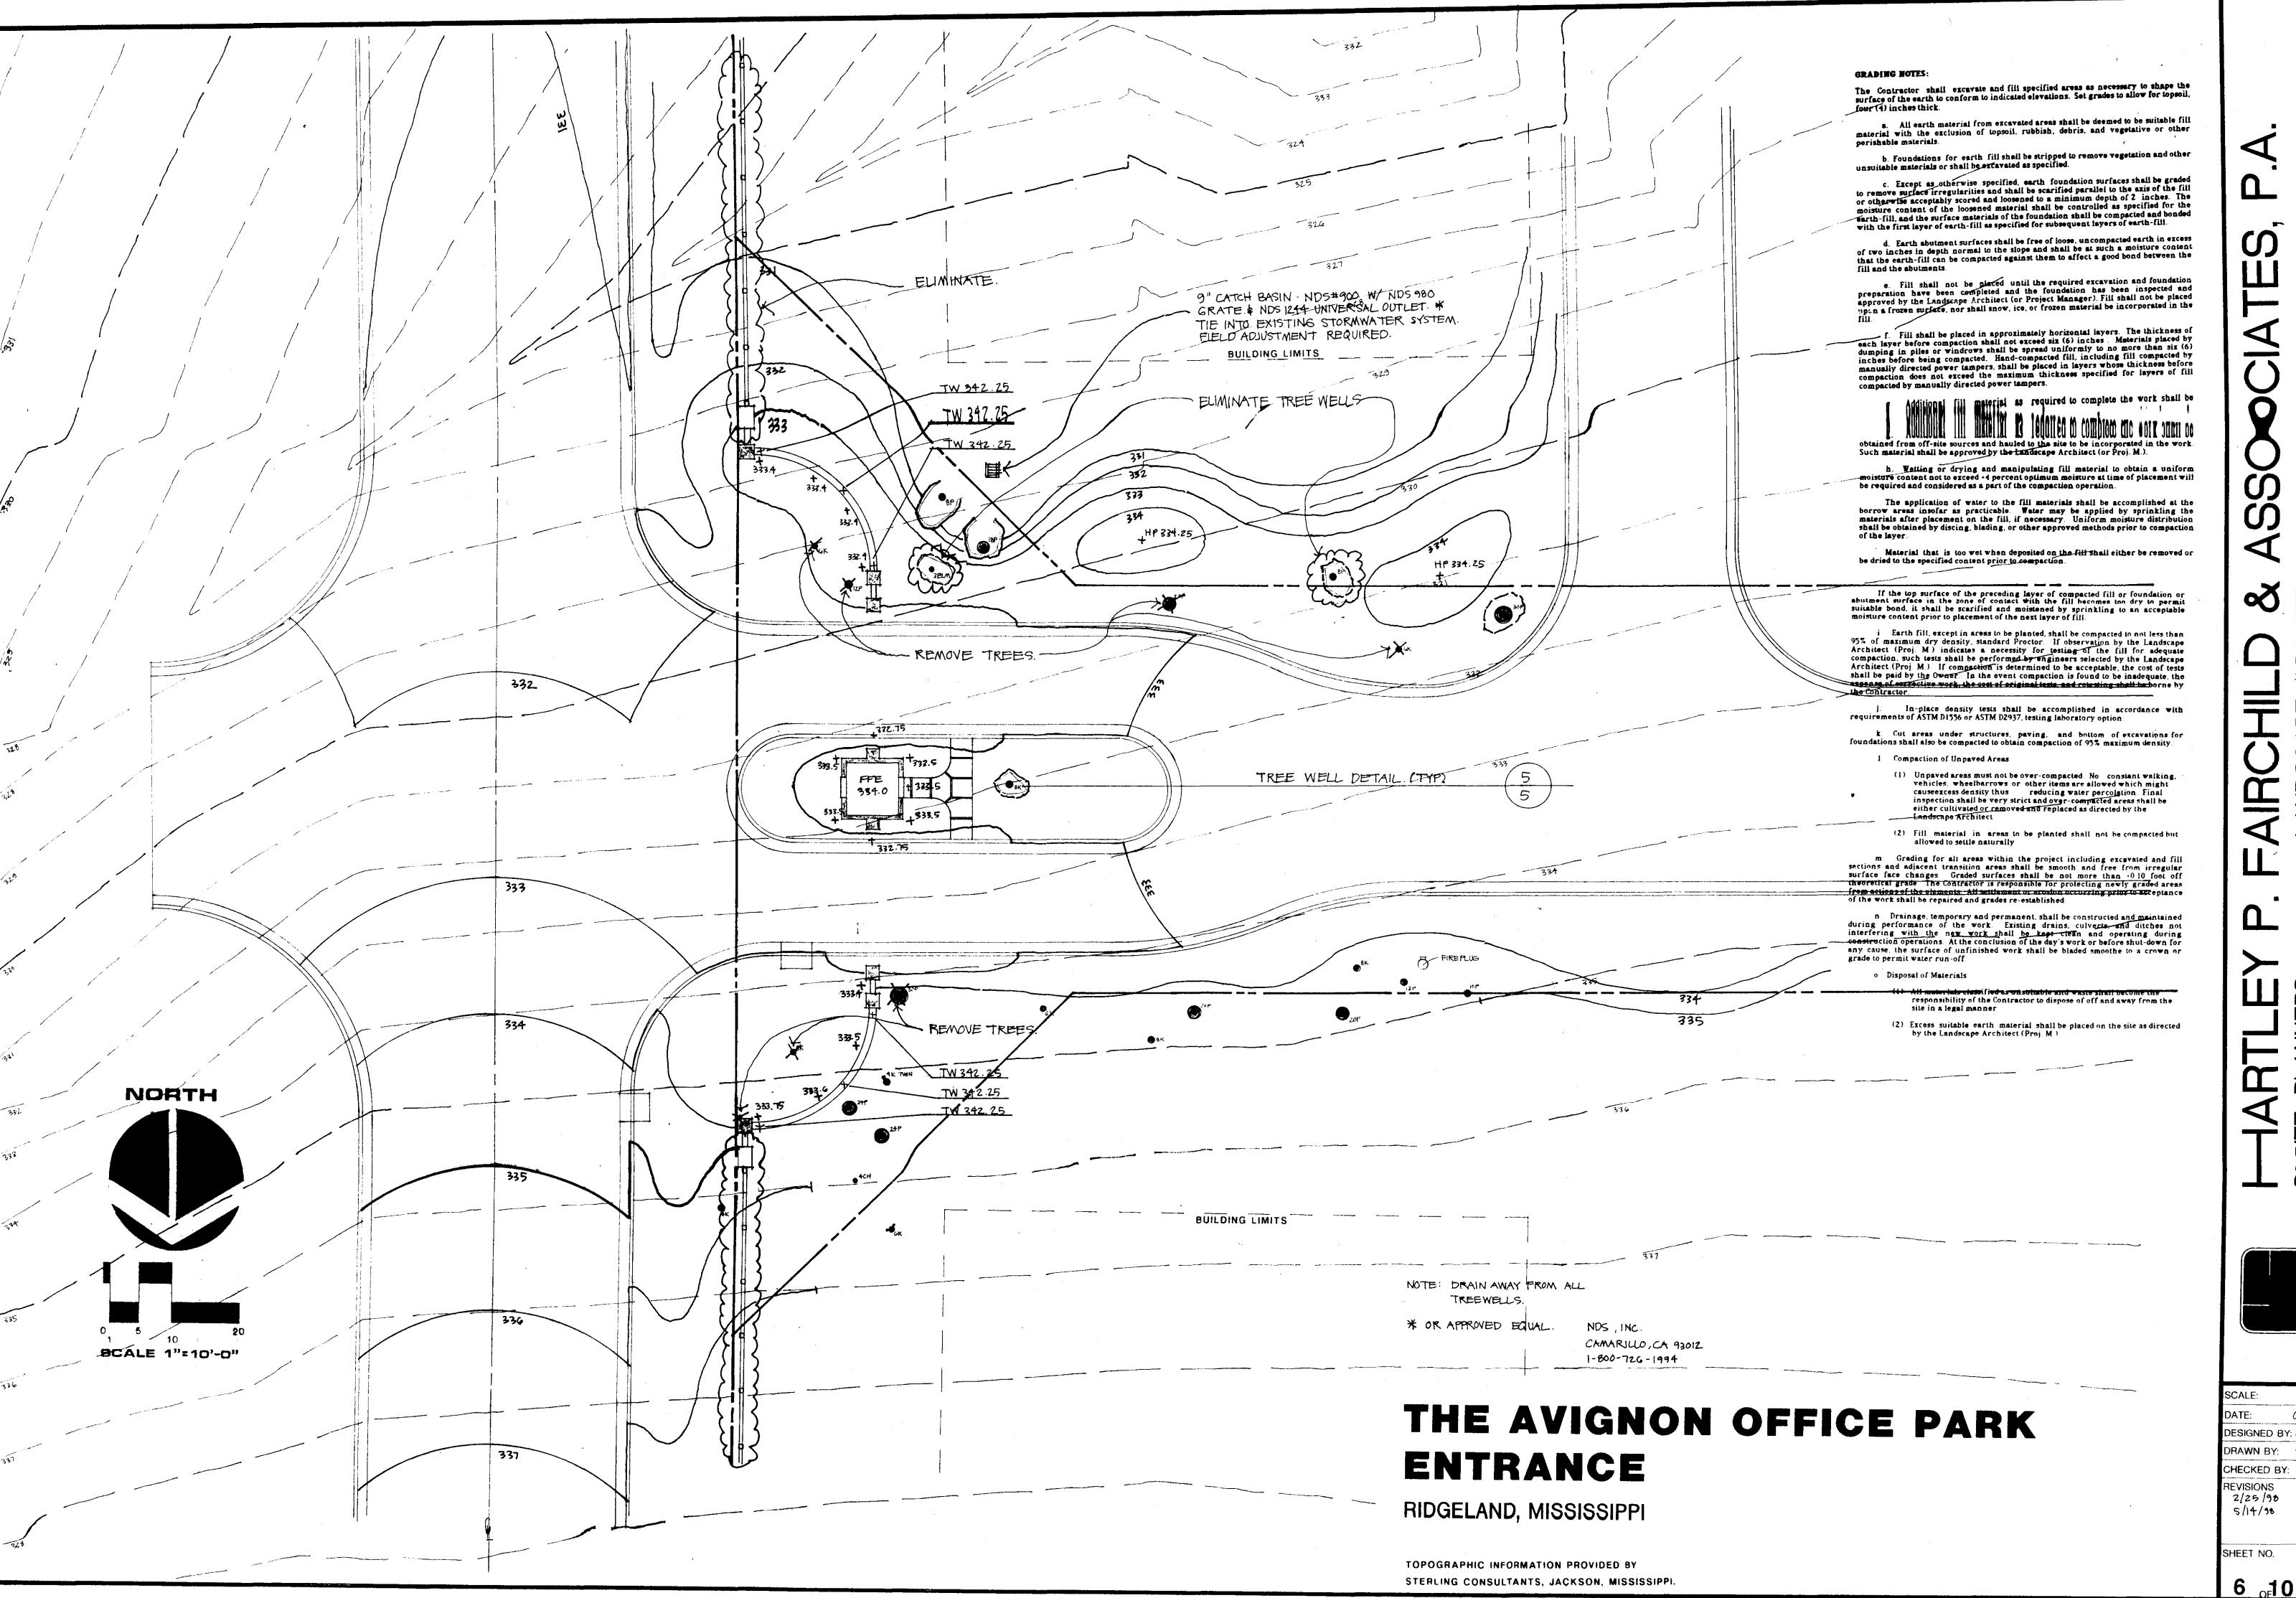



PLANT LIST:

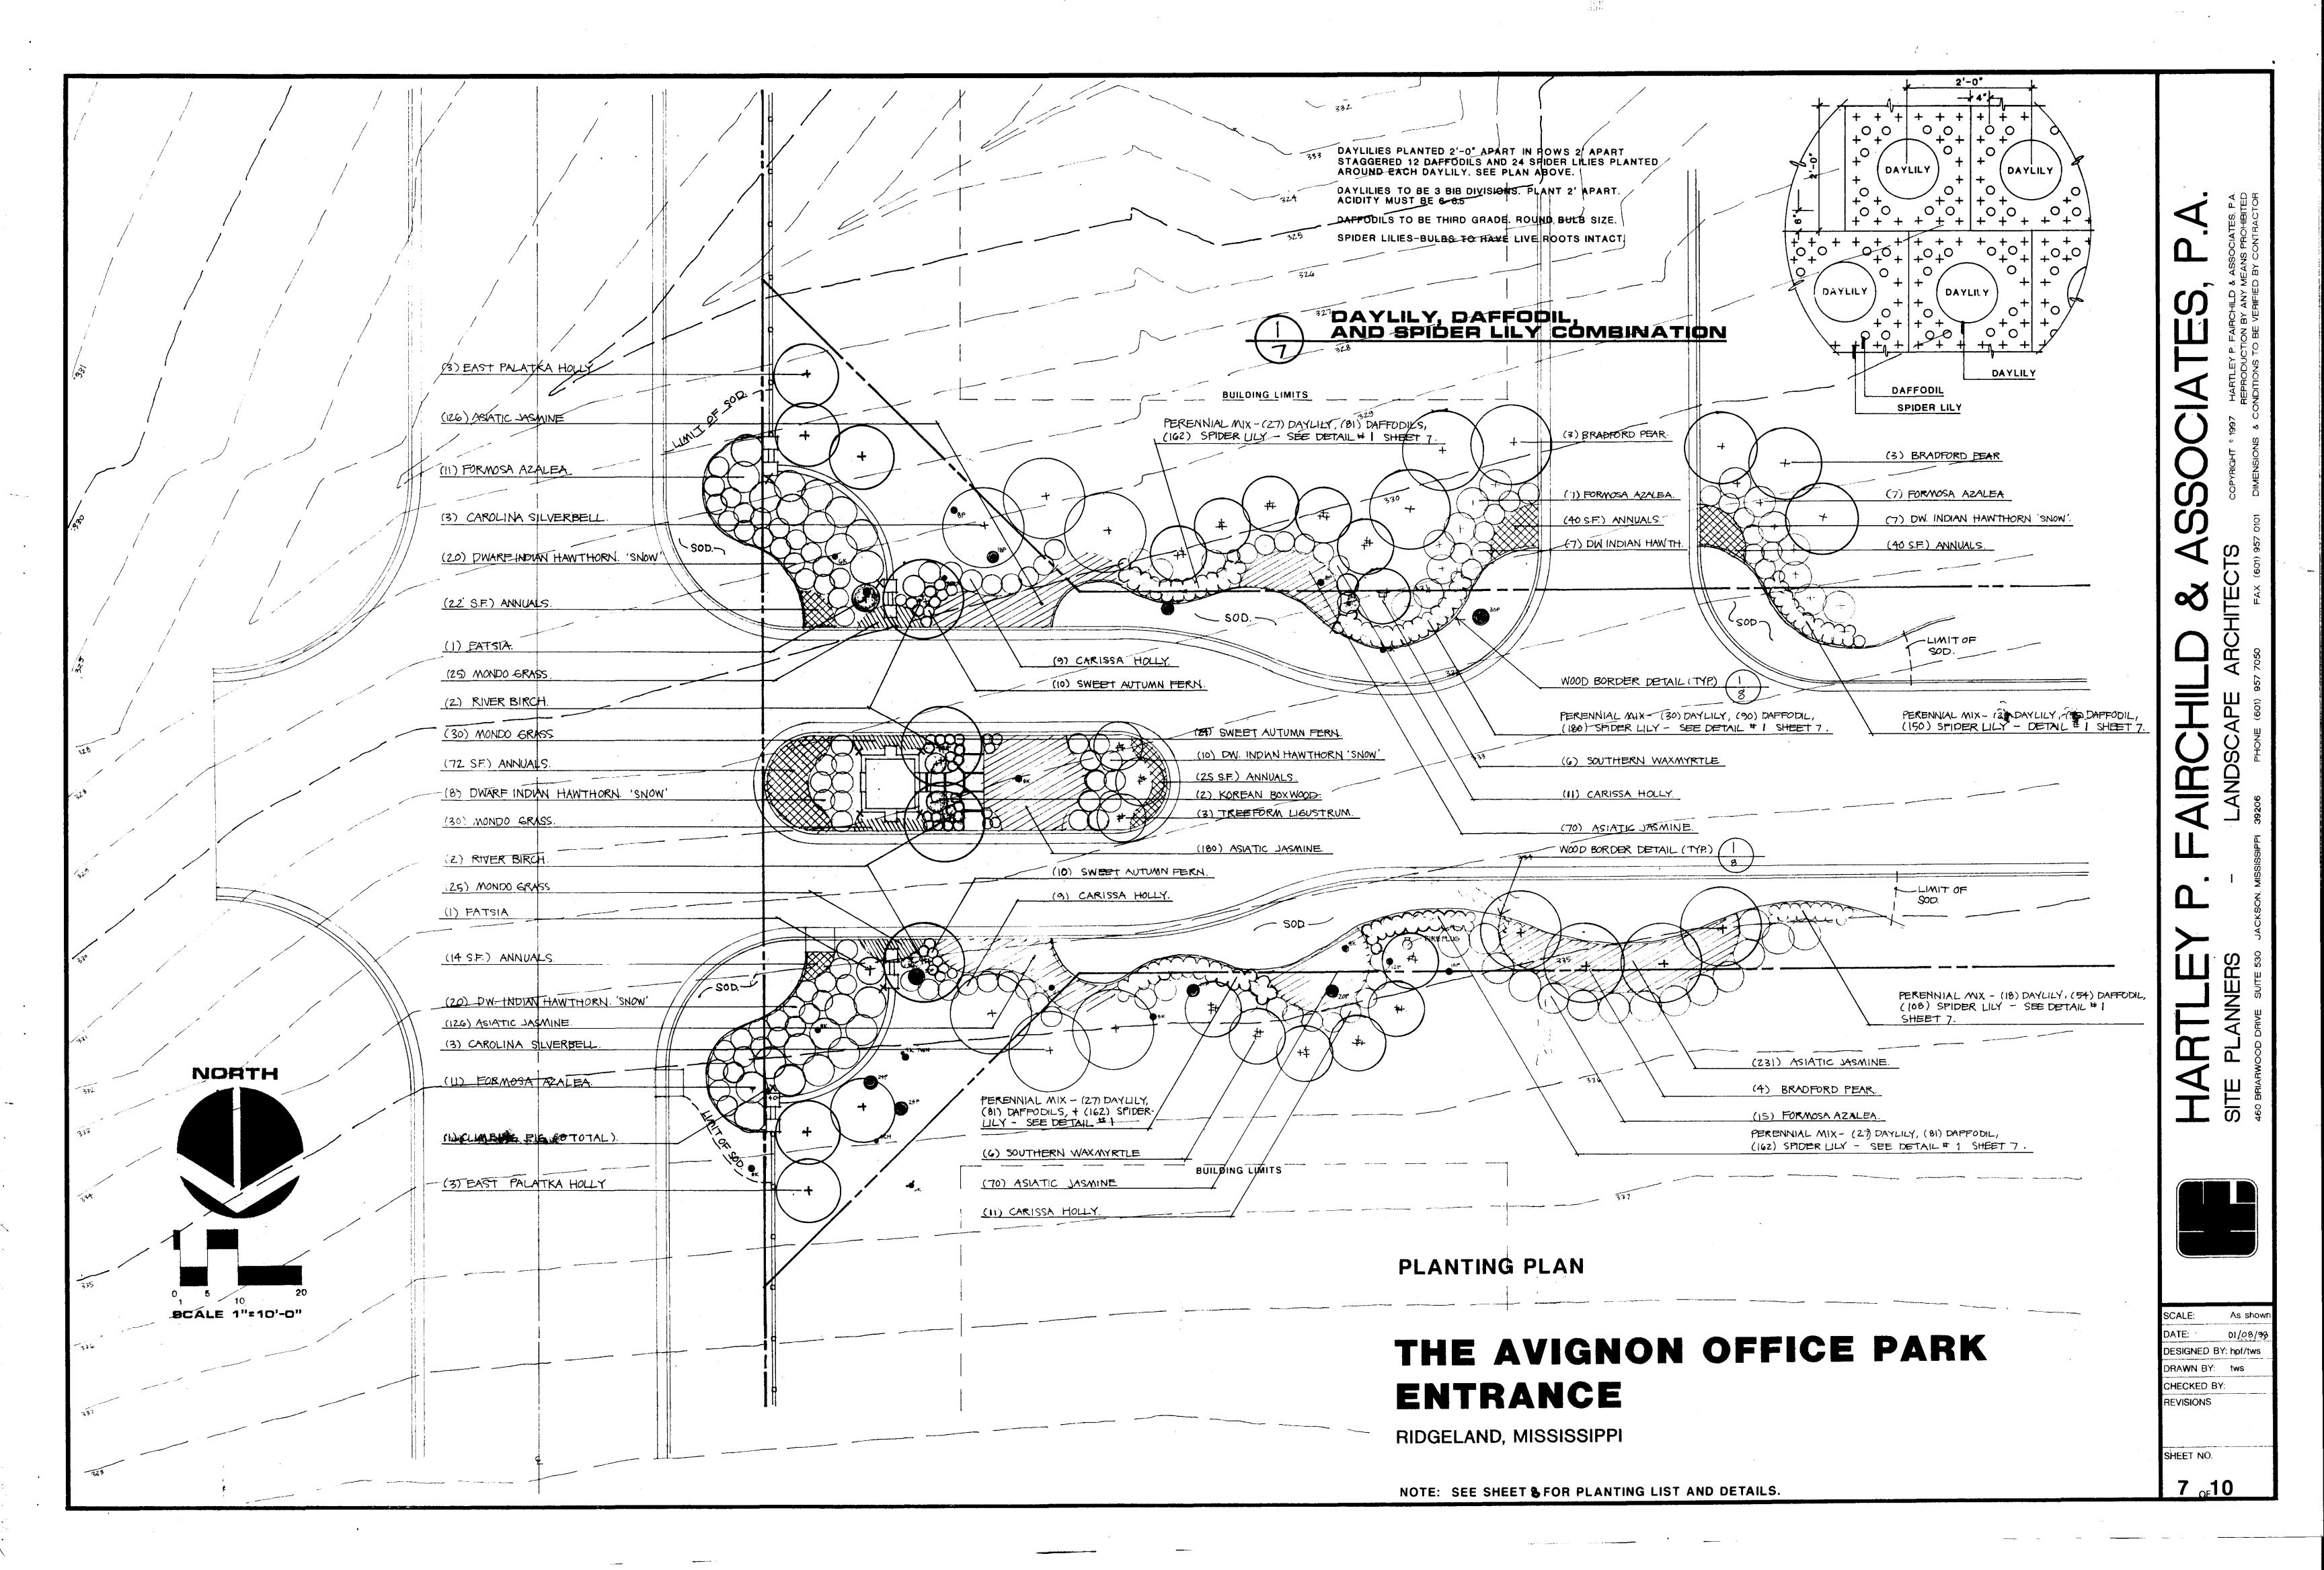
COMMON NAME	SCIENTIFIC NAME	QUANTITY HEIGHT	SIZE COST TOTAL	REMARKS
TREES	*			
BRADFORD PEAR	PIRUS CALLERY ANA 'BRADFORD'	10 8'-10'		SINGLE TRUNK
CAROLINA SILVER BELL	HALESIA DIPTERA 'CAROLINA'	6 8'-10'		WELL FORMED, SINGLE TRUNK
EAST PALATKA HOLLY	ILEX OPACA 'EAST PALATKA'	6 10'-12'		SINGLE TRUNK
REEFORM LIGUSTRUM	LIGUSTRUM JAPONICUM	3 6'-8'		3-5 TRUNKS, TREEFORM
RIVER BIRCH	BETULA NIGRA	4 12'-14'		3-5 TRUNKS, UPRIGHT
SOUTHERN WAXMYRILE	MYRICA CERIFERA	12 8'-10'		3-5 TRUNKS, SPREADING
<u> </u>				
SHRUBS	· · · · · · · · · · · · · · · · · · ·			
JAPANESE FATSIA	FATSIA JAPONICA	2	4 GAL.	SPECIMEN, WELL FORMED, SPACED 3' OC.
CARISSA CHINESE HOLLY	ILEX CORNUTA 'CARISSA'	40	3 GAL.	SPECIMEN, WELL FORMED, SPACED 3' OC.
DWARE INDIAN HAWTHORN	RAPHIOLEPIS INDICA 'SNOW'	72	3 GAL.	SPECIMEN, WELL FORMED, COMPACT FORM, WHITE BLOOM, SPACED 3' OC.
FORMOSA INDIAN AZALEA	AZALEA INDICA 'FORMOSA'	51	5 GAL.	SPECIMEN, WELL FORMED, FUSCIA BLOOM, SPACED 4' OC.
SOREAN BOXWOOD	BUXUS KOREANA	2	3 GAL.	SPECIMEN, WELL FORMED, SPACED 2' OC.
VINES, GROUNDCOVER				THE RESIDENCE OF THE PROPERTY
ASIATIC JASMINE	TRACHELOSPERMUM ASIATICUM	883	4" POTS	HEALTHY PLANTS, THREE 12" MIN. RUNNERS/POT, SPACED 12" OC.
10NDO GRASS	OPHIOPOGON JAPONICUS	110	4" POT	HEALTHY PLANTS, SPACED 9" OC.
BWEET AUTUMN FERN	DRYOPTERIS ERYTHROSORA	44	6" POT	SPACED 12"OC.
SLIMBING FIG	FICUS PUMILA	8	I GAL.	HEALTHY PLANTS
SEASONAL COLOR				
ANNUALS		213 SF		BY OWNER
PERENNIALS	and the second s			The second secon
DAFFODIL		462		TO BE SELECTED BY LANDSCAPE ARCHITECT
DAYLILY		154	CLUMP	TO BE SELECTED BY LANDSCAPE ARCHITECT
3PIDERLILY		924		TO BE SELECTED BY LANDSCAPE ARCHITECT
TURFGRASS				*** The state of t
CENTIPEDEGRASS	EREMOCHLOA OPHIUROIDES	233 SF	500	WEED FREE
PRE-EMERGENT HERBICIDE	The state of the s			
BED PREPARATION		+/- 3,800 SF		
PRE-EMERGENT HERBICIDE		+/- 3,800 SF	/ \ \ \ \ \ \ \ \ \ \ \ \ \ \ \ \ \ \ \	A STATE OF THE PARTY OF THE PAR
RE-EI IERGENT HERBIGIDE		77 3,000 31		
MULCH				
INDER SHRUBS AND TREES - 4" COMPA	CTED DINE ATRAIL	+/- 2,400 SF		
	ERENNIALS- 2" COMPACTED PINE STRAW	+/- 1,400 SF		
SINDER GROUND COVER, ANNUALS, AND P	ENDINIALS 2 COMPACIED FINE STRAW	17-1,400 37		
WOOD BODDER		./ 227.15		
WOOD BORDER		+/- 337 LF		
		1	1 1	

QUANTITY ESTIMATES HAVE BEEN MADE CAREFULLY, BUT THE LANDSCAPE ARCHITECT ASSUMES NO LIABILITY FOR OMISSIONS OR ERRORS. ESTIMATES ARE ONLY AN AID TO CLARIFICATION OF UNITS AND A CHECK FOR THE CONTRACTOR TO COMPARE WITH HIS OWN ESTIMATES. DIFFERENCES WILL BE BROUGHT TO THE ATTENTION OF THE LANDSCAPE ARCHITECT, NO EXTRA COMPENSATION SHALL BE ALLOWED FOR EXTRA QUANTITIES NECESSARY TO COMPLETE THE WORK. VERIFY ALL QUANTITIES ON SITE TO BE CERTAIN PLANTS FILL THE AREA TO BE LANDSCAPED.



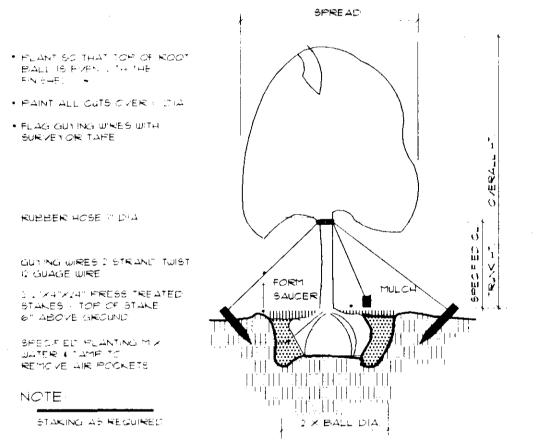

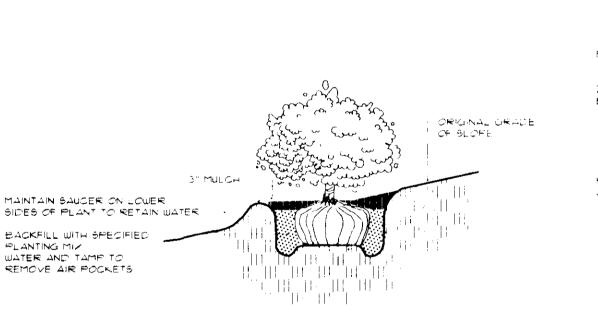

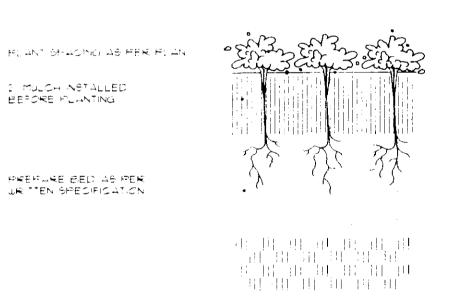

MULTI-TRUNK TREE STAKING

TREE PLANTING - GUY WIRES

SHRUB PLANTING ON SLOPES

SCALE: NOT TO SCALE


GROUNDCOVER PLANTING DETAIL

SCHIE MOTTO SCALE

FORT SAUCER WITH TO REMOVE AIR

SCALE NOT TO SCALE

SCALE NOT TO SCALE

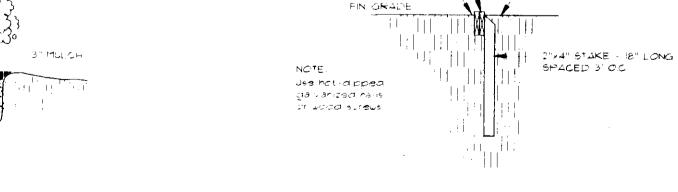

TWO TIMATED WITH STAGGERED JOINTS

1/21 ABOVE FIN. GRADE



SHRUB PLANTING

SCALE NOT TO SCALE

LAYOUT NOTES:

Staking of the plan on the site is the responsibility of the Contractor. This staking is subject to various degrees of adaptation on the site which can only be made by the Landscape Architect (Project Manager). This variation is an aesthetic decision and the amount of adjustment is most often determined by the existing trees, if any, by the variation of terrain, by the soil conditions, by the sub-drainage of water and by other intangibles on the site which are impractical to survey in absolute accuracy. For this reason, a part of the construction process is the adjustments of the plan by the Landscape Architect (or Proj. M.) to fit the site.

The process of staking is as follows:

a.The Contractor shall stakeout the entire site -- both as to location of all items and grades.

b.Prior to any tree removal, grading, construction or any other work except staking on the site, the Landscape Architect (orProj. M.) shall adjust the stakeout to fit the trees,topography and all other objects and conditions of the site and shall clearly mark all trees and vegetation to be removed. All alignment, dimension, grading, trenching, and planting shall be adjusted to save trees and vegetation not specifically labeled to be removed. e.At this meeting, the Contractor shall be on the site along with the person or persons who will superintend all the work under this contract. d.The Contractor and the Landscape Architect (or Proj. M.) shall go over each construction item and make sure there is a clear understanding of the drawings

e.This inspection/staking process shall be repeated for all work not staked and adjusted on the first trip. No work shallever be done without the stakeout first being approved by theLandscape Architect (or Proj. M.).

Existing utility lines shown on the drawings, such as cables, ducts, conduits, and piping shall, if damaged, (unless they are to be abandoned) be immediately repaired, protected, and maintained n use until relocation of same has been completed or shall be cut and capped where directed or shall be prepared for service connections when so required.

Any utilities encountered that are not shown on the drawings and that are to remain as active utilities, if inadvertently damaged by the Contractor, shall be repaired by him.

The Contractor shall be responsible for all field engineering required for construction, furnishing all lines, grades and control points necessary.

All materials to be distributed on the site will be done in the presence of the Landscape Architect (or Proj. M.). All Plant materials to be approved by the Landscape Architect (or Proj. M.) prior to installation.

Spread topsoil from stockpile four (4) inches deep over all areas disturbed by cut and fill operations, except where earth is to be covered by paving, walks, or other

Provide suitable approved topsoil from off site for completion of work in the event sufficient material is not available on the site. Topsoil shall not be compacted, but allowed to settle naturally. For planting bed preparation, base till the existing soil to a depth of 3" and mix in sand so that the base till composition is 30%-40% sand. To further prepare the soil, add 2" approved topsoil 2" bark and 2" sand. The mininum depth of soil preparation including base till is 9"

Apply systemic herbicide to existing grass cover. Till areas to recieve sod and remove loose grass and debris by hand raking the topsoil. Spread it over the required areas to give a 1" layer of adequate growing medium for turfgrass. Fertilizer and lime to be applied according to soil sample if provided by the Landscape Architect (or Proj. M.). Sod shall be applied in a uniform and even manner with no open spaces between sod pieces. Sod shall then be rolled immediately after first watering to give a level and uniform appearance

GUARANTEE:

The contractor will guarantee all work under this contract to be free from defects of material and workmanship for a period of one year from the date of acceptance by the Landscape Architect (or Proj. M.) except as otherwise agreed upon in writing by the parties to the contract.

All plants and lawns will be guaranteed for a cycle of one full growing season or one full year, whichever happens to be the longer guarantee period. This guarantee becomes effective on the date of asseptance by the Landscape Architect (or Proj. M.). Whenever work or plant replacement is required under the guarantee, the Contractor when notified by the Landscape Architect (or Proj. M.) must immediately: Place in satisfactory condition all work designated by the Landscape ARchitect

Make good any work or materials or grounds or lawn areas as necessary which have become eroded. All replacement at the end of the one year guarantee will be subject to the same guarantees as required for the first year. Theft, violent weather and drought damage are the responsibility of the Contractor until final preliminary approval is given on the site. Repair of such damage is the

responsibility of the Owner from the day preliminary approval of the entire job is

given until the end of the guarantee period.

PLANTING DETAILS


THE AVIGNON OFFICE PARK **ENTRANCE**

RIDGELAND, MISSISSIPPI

. As show 1/13/98 DESIGNED BY: tws DRAWN BY: CHECKED BY: REVISIONS

SHEET NO.

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LIGHTING LIST AND DETAILS

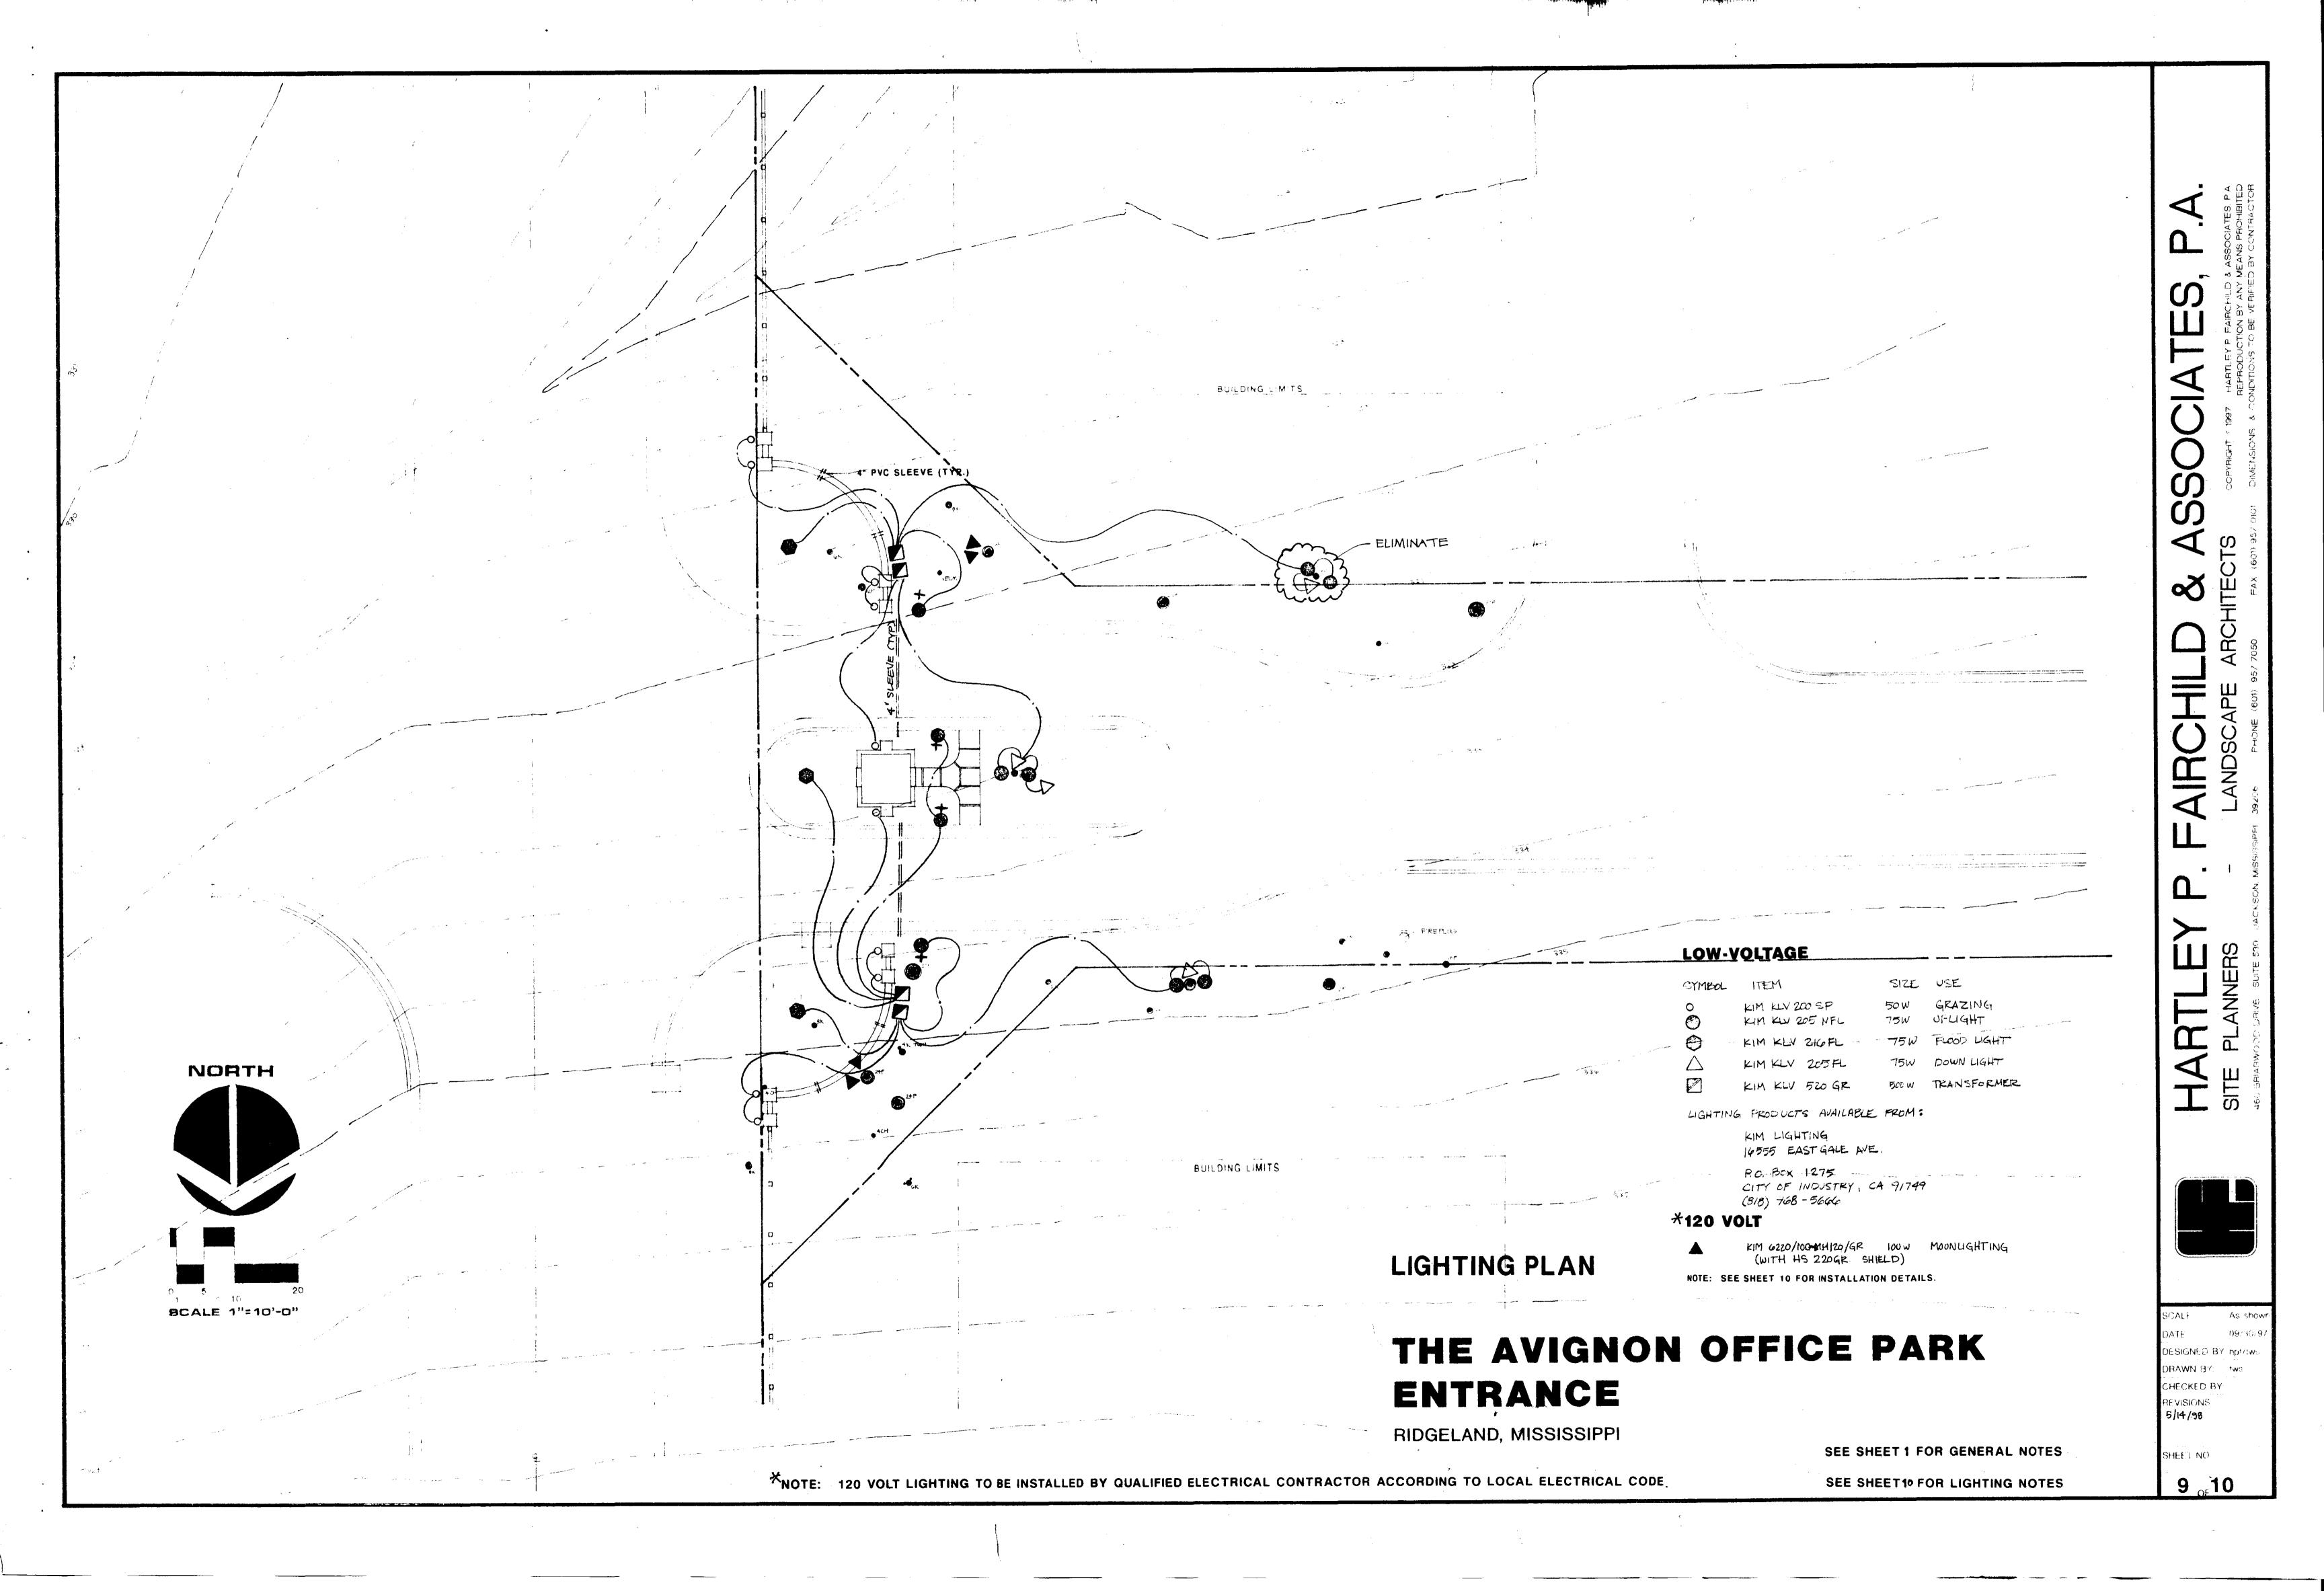ITEM	QTY.	SIZE	UNIT PRICE	REMARKS
KIM KLV 200SP	10	50 W		GRAZING
KIM KLV 205 NFL	10 - 8	75W	The state of the s	UPLIGHT
KIM KLV ZIGFL	3	75W		FLOOLIGHT
KIM KLV 205 FL	* 3	7 5 µ		DOWNLIGHT
KIM KLV 520 GR	4	500 H		TRANSFORMER
KIM 6220/100 MH 120/GR	4	IOO W		USE HS 220GR SHIELD
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Plan indicates number and types of tixtures only. Location shown is approximate Layout by the contractor and adjustment by the Lands de Architect for Project. Manager) is absolutely necessary prior to installation

HU Wolf weather proof fixtures outlets swit he enlighed integranging with her (All Electrical Work) that be initialled in a condince with a decent be all odes. Install ground interruptor switches with all exterior highting

. Odf transformers half to installed node, when 12° above grade on averso, tor-

I av voltage lighting. The sold treatment in Loneral Note: - Uniterproduct 1 (Maption to 165); to Important Mine #12 (ASSM or #1) (上海东世E Micronium rum teneritie that to the thoughter "in your farcer, after such as "it and te most other numericans on a purchase knowledge Lands upo An Internitor Prof. M. S. to be empt dime. The two object half be black or than outs ray

All since wire enter that in the mode's dark by the point in Chap Tite plants. sweet in any forced states, went to inside a fit to the penting of

To pleasify zare to among during future exceptations orange plastic rittion shall be lad in the trench with the wire prior to be killing.

Attacle, to sel warms come to be one paid from view. Pewew with the Lands are Architect (or Proj. M.) prior to instillation of wiring runs

- Catde chall be installed at 6° mirrimum depth.

· four metric (47) cheevings chieff the provided by the contractor under all hardscape. specificate diffate futures able installation -

All toples to be collibropped (MPSE 5-55 - Coop)

Light Fixtures shall be mounted onto limb, of trees when structurally appropriate. with one and a half in h. (1.172) calconized release. It may be necessary to wife come fixtures in the e-when limbs are too small to had be power. Peyrow all mounting s with the Loudz ope Architect (or Prog. M.).

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The Contractor shall exercise rescond lessore Juring the excavation work to avoid. unne errory demoge to any unknown underground objects encountered. The completor will not be held responsible for such damage provided rescandable mutons. is indicated and he has utilized all available resources to locate any timiled of statles. Any interference, or damage, thalf be reported to the Larch ope Architect for Proc.

Attrivinger thall be solveted by the Lands ape Architect (or Prog. M) and approved.

EATOUT NOTES

Staking of the plan on the site is the responsibility of the Contractor. This staking is subject to various degrees of adaptation on the site which can only be made by the Landscape Architect for Project Manager). This variation is an aesthetic decision. and the amount of adjustment is most often determined by the existing trees, if any, by the variation of terrain, by the soil conditions by the sub drainage of water and by other intangibles on the site which are impractical to survey in absolute accuracy. For this reason, a part of the construction process is the adjustment of the plan by the Landscape Architect (or Proj. M.) to fit the site


The process of staking is as follows


a The Contractor shall stakeout the entire site both as to location of all items and

h Prior to any tree removal grading construction or any other work except

reasonable time before the inspection must be made. The Landscape Architect (or Proj. M.) shall adjust the stakeout to fit the trees, topography and all other objects and conditions of the site and shall clearly mark all trees and vegetation to be removed. All alignment, dimensions, grading, trenching, and planting shall be adjusted to save trees and vegetation not specifically labeled to be

- c. At this meeting, the Contractor shall be on the site along with the person or persons who will superintend all the work under this contract The Contractor and the Landscape Architect (or Proj. M.) shall go over each
- e. This inspection / staking process shall be repeated for all work not staked and adjusted on the first trip. No work shall ever be done without the stakeout first heing approved by the Landscape Architect (or Prof. M.).

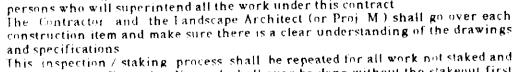

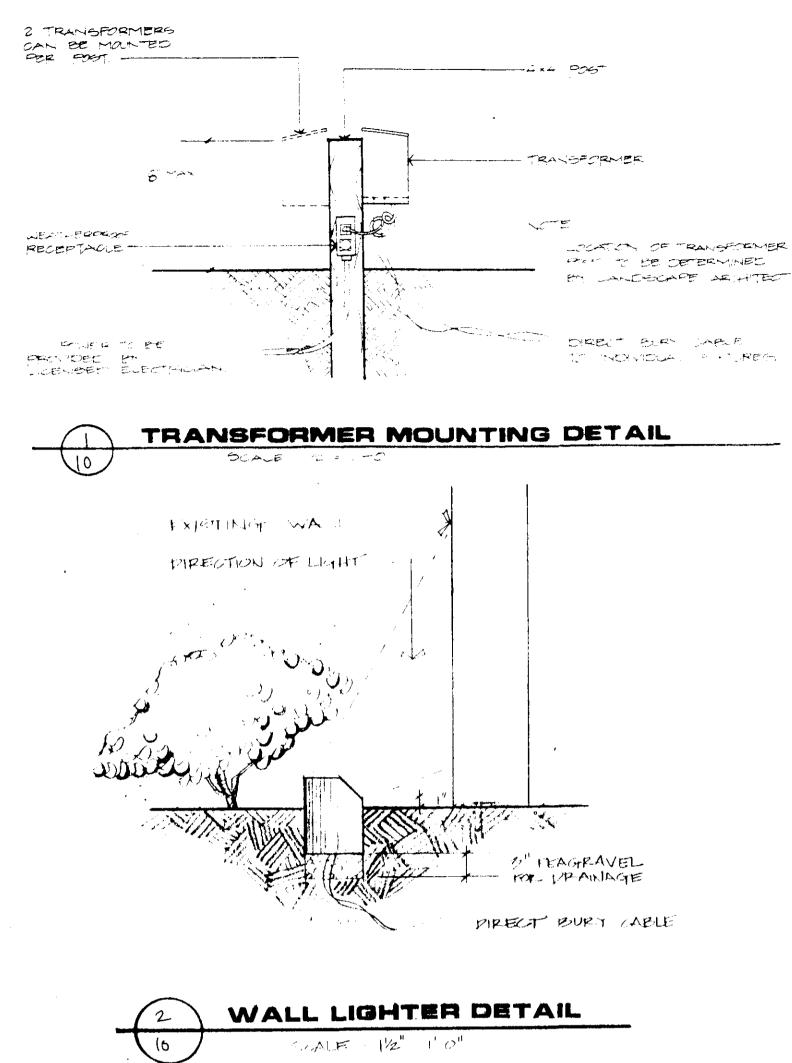

Existing utility lines shown on the drawings, such as cables, ducts, conduits, and piping shall if damaged (unless they are to be abandoned) be immediately renaired


Any utilities encountered that are not shown on the drawings and that are to remain as active utilities, if inadvertently damaged by the Contractor, shall be repaired by


so required


protected and maintained in use until relocation of same has been completed or shall

be cut and capped where directed or shall be prepared for service connections when

The Contractor shall be responsible for all field engineering required by construction, furnishing all lines, grades and control points necessary

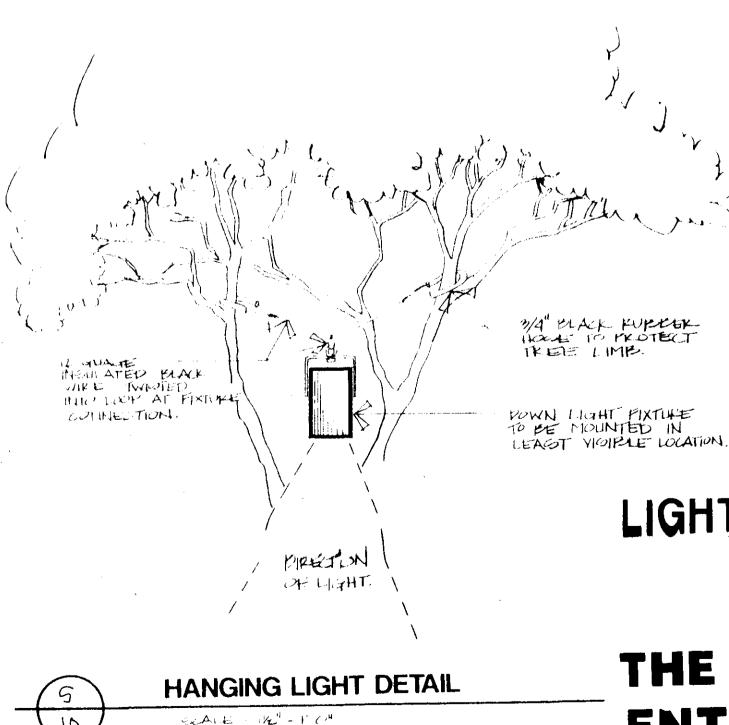

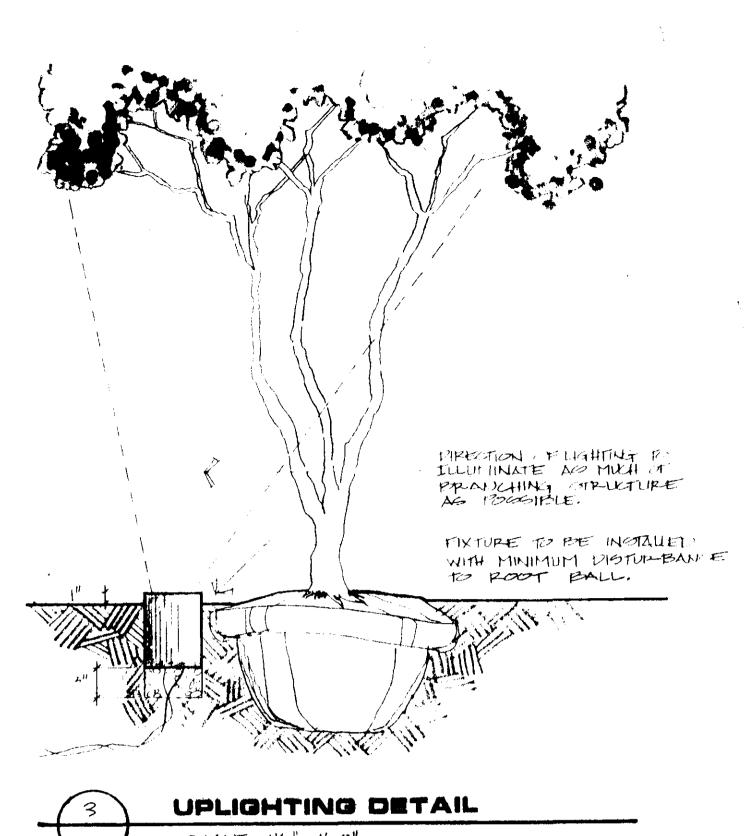

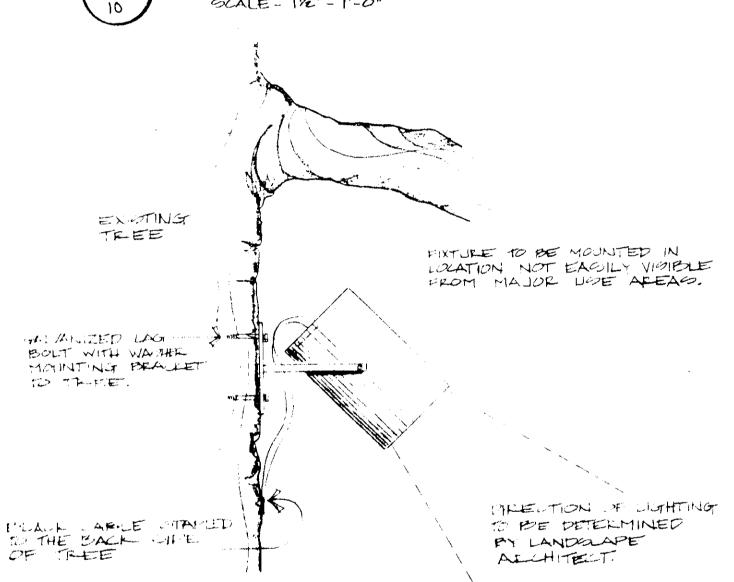



LIGHTING DETAILS

THE AVIGNON OFFICE PARK ENTRANCE

RIDGELAND, MISSISSIPPI

Z



SCALE: DATE: DESIGNED BY: DRAWN BY: CHECKED BY: REVISIONS:

SHEET NO.

5/14/90